

UNITED STATES DEPARTMENT OF VETERAN AFFAIRS EDWARD HINES, JR. V.A. ITC

BUILDING 215; HINES, ILLINOIS 60141-5000


NEW FIRE ALARM SYSTEM; CONTRACT VA69DP-0769A TASK ORDER # 23


CONSULTANTS

STRUCTURAL | MECHANICAL | ELECTRICAL TECHNOLOGY | MEDICAL EQUIPMENT SOLUTIONS

DRAWING INDEX

G001	GENERAL COVERSHEET
E001	ELECTRICAL COVER SHEET
E101	FIRST FLOOR PLAN - AREA A FIRE ALARM
E102	FIRST FLOOR PLAN - AREA B FIRE ALARM
E103	FIRST FLOOR PLAN - AREA C FIRE ALARM
E104	FIRST FLOOR PLAN - AREA D FIRE ALARM
E105	FIRST FLOOR PLAN - AREA E FIRE ALARM
E201	SECOND FLOOR PLAN - AREA A FIRE ALARM
E202	SECOND FLOOR PLAN - AREA B FIRE ALARM
E203	SECOND FLOOR PLAN - AREA C FIRE ALARM
E204	SECOND FLOOR PLAN - AREA D FIRE ALARM
EZ100	FIRST FLOOR PLAN - SPEAKER NOTIFICATION ZONE
EZ200	SECOND FLOOR PLAN - SPEAKER NOTIFICATION ZONE
E300	FIRE ALARM RISER
E400	ELECTRICAL SCHEDULES AND DETAILS

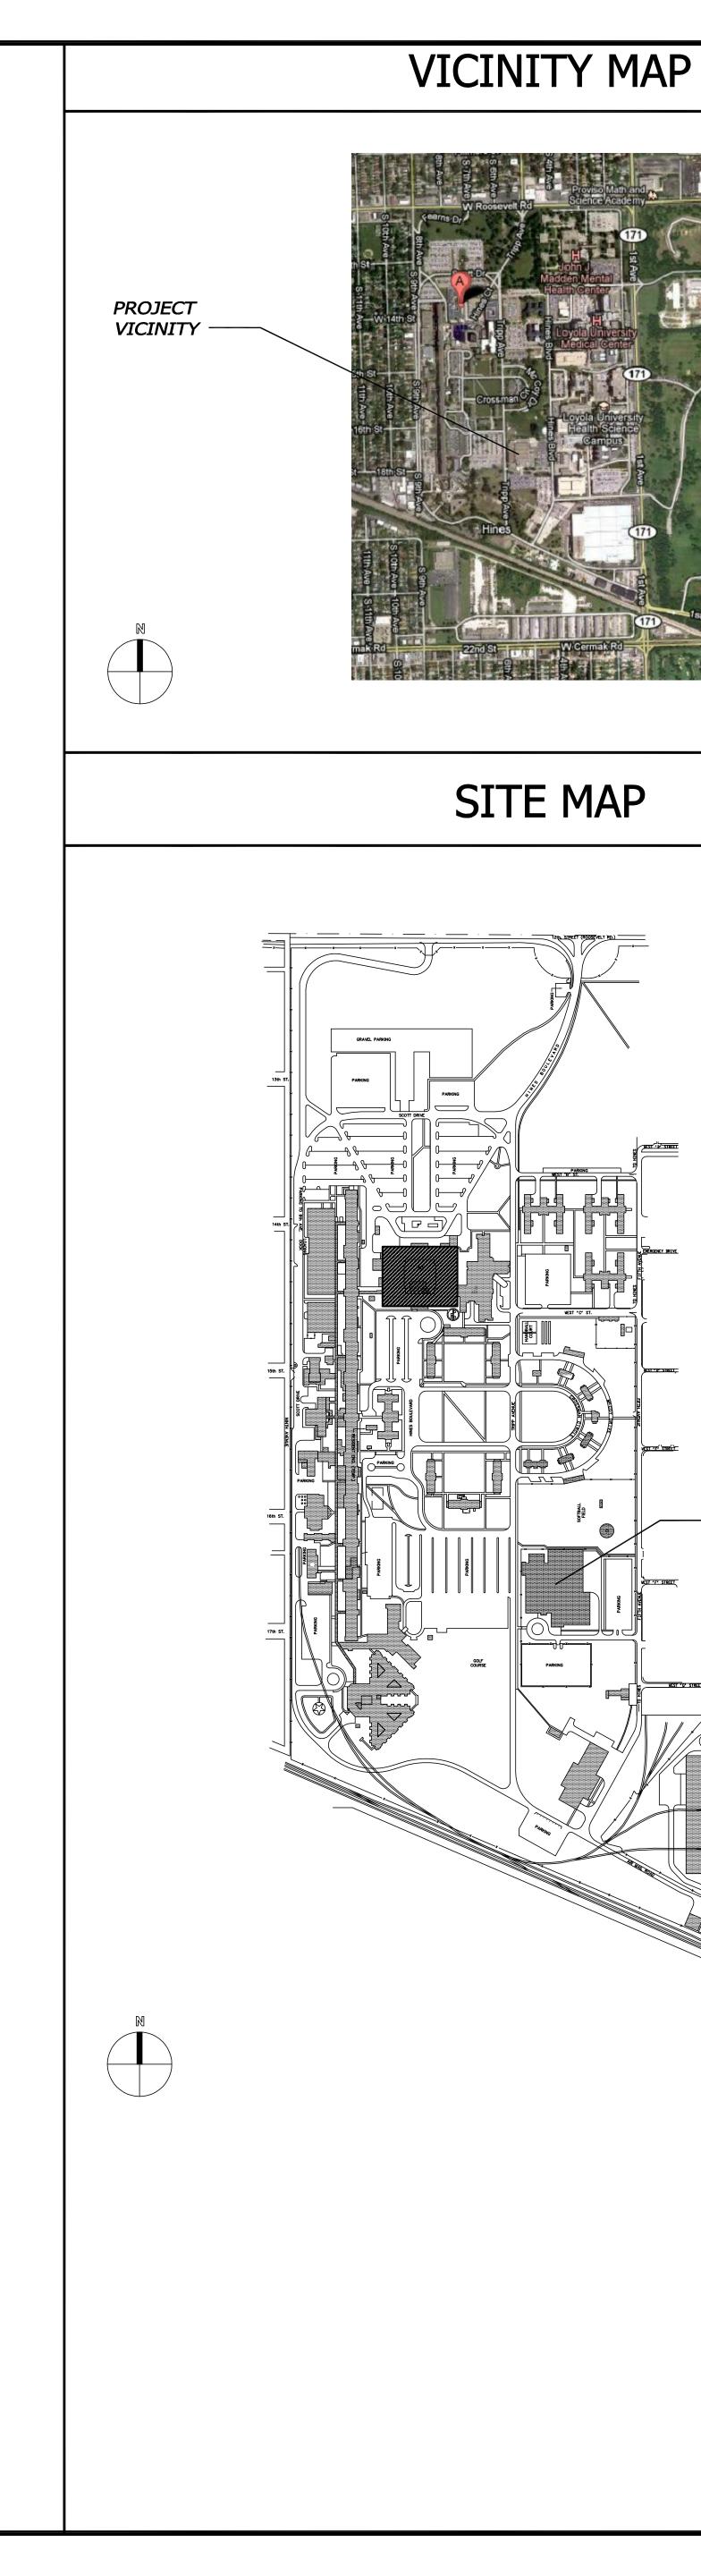

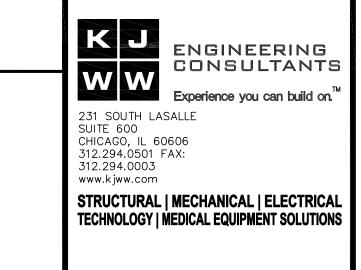



KJWW FNGINFFRING RESERVES PROPRIFTARY RIGHTS. INCLUDING COPYRIGHTS, TO THIS DRAWING AND THE DATA SHOWN THEREON. SAID DRAWING AND/OR DATA ARE THE EXCLUSIVE PROPERTY OF KJWW ENGINEERING AND SHALL NOT BE USED OR REPRODUCED FOR ANY OTHER PROJECT WITHOUT THE EXPRESS WRITTEN APPROVAL AND PARTICIPATION OF KJWW ENGINEERING. © 2009 KJWW, P.C REFERENCE SCALE IN INCHES ESIGNED BY DRAWN BY CHECKED B

11.0463.00 03.30.2012 GENERAL COVER SHEE 200 WEST JACKSON BOULEVARD SUITE 1200 CHICAGO, IL 60606 312.294.0501 FAX: 312.294.0003 Experience you can build on." www.kjww.com
PROJECT # 11.0463.00 KJWW ENGINEERING RESERVES PROPRIETARY RIGHTS, INCLUDING COPYRIGHTS TO THIS DRAWING AND THE DATA SHOWN THEREON. SAID DRAWING AND/OF DATA ARE THE EXCLUSIVE PROPERTY OF KJWW ENGINEERING AND SHALL NOT BE USED OR REPRODUCED FOR ANY OTHER PROJECT WITHOUT THE EXPRESS WRITTEN APPROVAL AND PARTICIPATION OF KJWW ENGINEERING. © 2009 KJWW, P.C.


REFERENCE SCALE IN INCHES

PROJECT LOCATION

BUILDING 215

SHEET NUMBER

REFER TO LUMINAIRE SCHEDULE FOR DIMENSIONS AND TYPES SYMBOL: DESCRIPTION: SINGLE FACE EXIT SIGN SHADING INDICATES ILLUMINATED FACE(S). ARROWS INDICATE DIRECTION TO EXIT COMBINATION EXIT AND EMERGENCY LIGHTING UNIT 2'X2' LAY-IN WITH BATTERY BACK-UP EMERGENCY LIGHTING UNIT

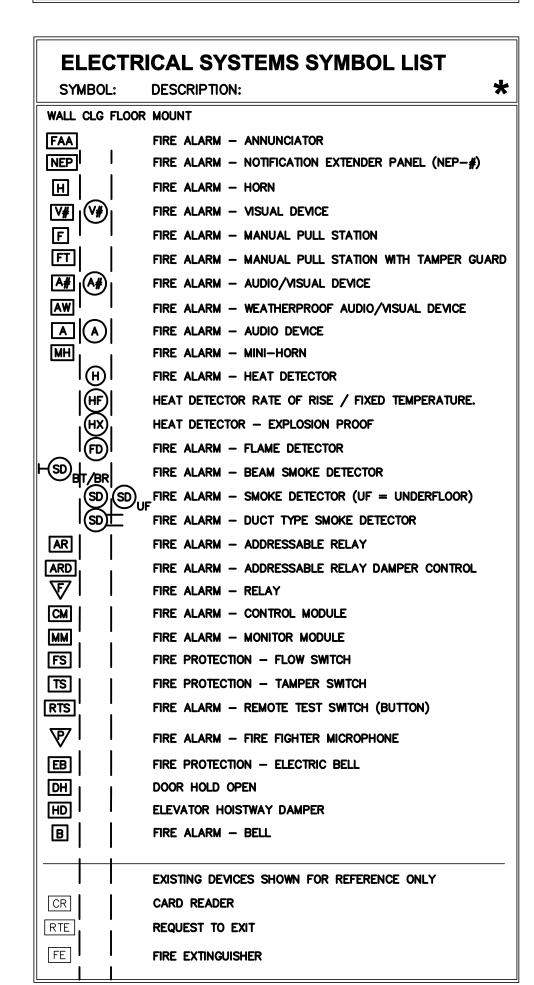

* ALL SYMBOLS AND ABBREVIATIONS
LISTED MAY NOT BE APPLICABLE TO
THIS PROJECT. REFER TO GENERAL
ELECTRICAL EQUIPMENT SCHEDULE
FOR MORE COMPLETE DESCRIPTION
AND ADDITIONAL SYMBOLS.

EXISTING FM200 SYSTEMS SYMBOL LIST (DEVICES SHOWN FOR REFERENCE ONLY TO REMAIN) RP-1001 PANELS LOCATED IN ROOMS 147B, 147X AND 147Y. SYMBOL: DESCRIPTION: FIRE ALARM - IONIZATION DETECTOR FIRE ALARM - PHOTOELECTRIC DETECTOR FIRE ALARM - ABORT SWITCH (EMERGENCY POWER OFF) FIRE ALARM - MANUAL PULL STATION FIRE ALARM - AUDIO/VISUAL DEVICE $\langle AV \rangle$ $\langle V \rangle$ FIRE ALARM - VISUAL DEVICE $\langle B \rangle$ FIRE ALARM — BELL < SD > FIRE ALARM - SMOKE DAMPER OR FIRE/SMOKE DAMPER FIRE ALARM - RP-1001 ANNUNCIATOR PANEL

	EXISTING PREACTION SUPPRESSION SYSTEMS SYMBOL LIST									
(DEVICES S	SHOWN FOR REFERENCE ONLY ALL TO REMAIN) N ROOM 100	*								
SYMBOL:	DESCRIPTION:									
EPO PR	FIRE ALARM - ABORT SWITCH (EMERGENCY POWER OFF))								
FPR	FIRE ALARM - MANUAL PULL STATION									
A# PR	FIRE ALARM - AUDIO/VISUAL DEVICE									
V	FIRE ALARM - VISUAL DEVICE									
B _{PR} o _{FIKE}	FIRE ALARM - BELL									
FIKE	FIRE ALARM - PRE ACTION PANEL									
SD	FIRE ALARM - SMOKE DETECTOR									
(SD) UF	FIRE ALARM - UNDER FLOOR SMOKE DETECTOR									
HSD BT	FIRE ALARM - BEAM SMOKE TRANSMITTER									
HSD BR	FIRE ALARM - BEAM SMOKE RECEIVER									

EXISTING PREACTION SUPPRESSION SYSTEMS SYMBOL LIST (DEVICES SHOWN FOR REFERENCE ONLY ALL TO REMAIN) LOCATED IN ROOM 166A,B,D SYMBOL: DESCRIPTION: H HEAT DETECTOR SD SMOKE DETECTOR

ELECTRICAL DEMOLITION SYMBOL LIST SYMBOL: DESCRIPTION: INDICATES EXISTING TO REMAIN ----- INDICATES EXISTING TO BE REMOVED. MOUNTED WALL CEILING FIRE ALARM - VISUAL DEVICE FIRE ALARM - MANUAL PULL STATION FIRE ALARM - AUDIO/VISUAL DEVICE FIRE ALARM - SMOKE DETECTOR ALARM BELL FIRE ALARM - ANNUNCIATOR FIRE ALARM - SMOKE DAMPER OR FIRE/SMOKE DAMPER FIRE ALARM - ADDRESSABLE RELAY SINGLE OR DOUBLE FACE EXIT SIGN EMERGENCY LIGHTING UNIT

ELECTRICAL DEMOLITION NOTES:

- THE ELECTRICAL DRAWINGS INDICATE EXISTING ELECTRICAL ITEMS TO BE REMOVED.
 THE DRAWINGS ARE INTENDED TO INDICATE THE SCOPE OF WORK REQUIRED AND DO
 NOT INDICATE EVERY BOX, CONDUIT, OR WIRE THAT MUST BE REMOVED. THE
 CONTRACTOR SHALL VISIT THE SITE PRIOR TO SUBMITTING A BID AND VERIFY
 EXISTING CONDITIONS.
- 2 ELECTRICAL ITEMS (i.e., LIGHTING FIXTURES, SWITCHES, ETC.) REMOVED AND NOT RELOCATED REMAIN THE PROPERTY OF THE OWNER. THE CONTRACTOR SHALL BE RESPONSIBLE FOR THE DISPOSAL OF MATERIAL THE OWNER DOES NOT WANT TO REUSE OR RETAIN (i.e., FOR MAINTENANCE PURPOSES).
- THE CONTRACTOR SHALL OBTAIN APPROVAL FROM THE OWNER BEFORE TURNING OFF POWER TO CIRCUITS, FEEDERS, PANELS, ETC. COORDINATE ALL OUTAGES WITH OWNER. CONDUIT CONCEALED IN WALL CONSTRUCTION MAY BE ABANDONED IN PLACE IF NOT AFFECTED BY OTHER CONSTRUCTION.
- THIS CONTRACTOR SHALL COORDINATE ALL HIS WORK WITH OTHER CONTRACTORS AT THE JOB SITE BEFORE REMOVING EXISTING ELECTRICAL AND INSTALLING NEW ITEMS.
- 5 EXISTING CONDUIT IN GOOD CONDITION, MAY BE REUSED IN PLACE. RELOCATED EXISTING CONDUIT SHALL NOT BE ALLOWED. BONDING CONDUCTORS SHALL BE
- 6 EQUIPMENT REMOVAL IN CERTAIN LOCATIONS MAY REQUIRE THE INSTALLATION OF A JUNCTION BOX TO RECONNECT CIRCUITS THAT REMAIN IN OPERATION. EXTEND CONDUIT AND WRING AS REQUIRED TO MAINTAIN POWER TO REMAINING EQUIPMENT.

INSTALLED IN ALL REUSED CONDUIT TO ASSURE PROPER GROUND PATH.

GENERAL ELECTRICAL NOTES:

- 1 "1/E301" INDICATES DETAIL NUMBER/SHEET NUMBER.
- INDICATES KEYED NOTE USED TO DESCRIBE ADDITIONAL INFORMATION OF WORK REQUIRED, SPECIFIC TO THE SHEET AND/OR DETAIL IT IS SHOWN WITH.

 SHADED LUMINAIRE OR DEVICE INDICATES LUMINAIRE OR DEVICE IS CONNECTED TO AN EMERGENCY CIRCUIT.
- 4 ALL ELECTRICAL CONDUCTORS SHALL BE COPPER.
- 5 -//-INDICATES NUMBER OF WIRES IN CONDUIT.
 - GROUND WIRE
 NEUTRAL WIRE
 NEUTRAL WIRE
 - NEUTRAL WRE PHASE WRE
 ABBREVIATION KEY:
 - E.C. ELECTRICAL CONTRACTOR
 M.C MECHANICAL CONTRACTOR
 G.C. GENERAL CONTRACTOR
 AFF ABOVE FINISHED FLOOR
 CONDUIT
 - COTR CONTRACTING OFFICER OF RECORD
 - MOUNTING SUBSCRIPT KEY:
 - +# MOUNTING HEIGHT FROM FINISHED FLOOR TO CENTERLINE

 a RECEPTACLES:
 - A MOUNT ABOVE COUNTER (+6" TO CENTERLINE ABOVE COUNTER OR BACKSPLASH)

 L MOUNT IN LAB CASEWORK
- 8 LINE TYPE KEY:
- NEW WORK BY THIS CONTRACTOR (DARK SOLID LINE)

 NEW WORK BY OTHERS AND/OR EXISTING TO REMAIN (LIGHT SOLID LINE)

 EXISTING TO BE REMOVED BY THIS CONTRACTOR (DARK SHORT DASHED LINE)

ELECTRICAL INSTALLATION NOTES:

- 1. THE COMPLETE INSTALLATION SHALL BE IN ACCORDANCE WITH THE ADAAG (AMERICANS WITH DISABILITIES ACT ACCESSIBILITY GUIDELINES).
- 2. CIRCUIT NUMBERS ARE SHOWN FOR CIRCUIT IDENTIFICATION. CIRCUITING SHALL AGREE WITH NUMBERING ON THE PANEL PROVIDED. COMMON NEUTRALS MAY NOT BE USED FOR BRANCH
 - CIRCUITS. BALANCE THE LOAD ON PANEL AS EVENLY AS POSSIBLE BETWEEN EACH PHASE.
- 3. CIRCUITS SERVING EMERGENCY AND EXIT LUMINAIRES WILL BE RUN IN SEPARATE RACEWAY FROM ALL OTHER CIRCUITS.
 4. MINIMUM OF A #12 GREEN INSULATED GROUND CONDUCTOR SHALL BE INSTALLED WITH CIRCUIT CONDUCTORS IN EACH HOME RUN.
- 5. CONCEAL ALL CONDUIT IN WALLS, PARTITIONS, ABOVE CEILING, AND IN FLOOR SLAB, ETC. UNLESS OTHERWISE INDICATED ON THE PLANS OR IN THE SPECIFICATIONS. CONDUIT IN MECHANICAL ROOMS, AND STORAGE ROOMS WITHOUT CEILINGS MAY BE EXPOSED ON BUILDING STRUCTURE. FISH FLEXIBLE CONDUIT IN EXISTING WALLS TO CONCEAL. WHERE WALL CONSTRUCTION DOES NOT ALLOW FISHING CONDUIT, DISCUSS POSSIBLE SOLUTION WITH THE OWNER AND ENGINEER BEFORE
- 6. BOXES LOCATED ON OPPOSITE SIDES OF NON-RATED WALLS SHALL BE OFFSET A MINIMUM OF 6" HORIZONTALLY. BOXES ON OPPOSITE SIDES OF FIRE RATED WALLS SHALL BE OFFSET A MINIMUM OF 24" HORIZONTALLY. "THRU-THE-WALL" BOXES SHALL NOT BE ALLOWED WITHOUT PRIOR WRITTEN APPROVAL OF THE ARCHITECT/ENGINEER.
- 7. CONTRACTOR SHALL COORDINATE THE LOCATION OF ANY DETECTORS AND/OR SPEAKERS WITH SPRINKLER AND CEILING DIFFUSERS WITH THE LIGHTING FIXTURE LAYOUT. CENTER ALL DEVICES IN CEILING TILE PATTERN. SMOKE DETECTORS SHALL BE LOCATED NO CLOSER THAN 3 FEET TO AN AIR SUPPLY DIFFUSER OR RETURN GRILLE.
- 3. CONTRACTOR SHALL BE RESPONSIBLE FOR ALL OPENINGS REQUIRED IN WALLS. ALL OPENINGS SHALL BE REPAIRED TO MATCH EXISTING BY A QUALIFIED CONTRACTOR AT THE EXPENSE OF THIS CONTRACTOR. ALL CONDUITS THROUGH WALLS SHALL BE GROUTED OR SEALED INTO OPENINGS.
- 9. ALL MATERIALS USED TO SEAL PENETRATIONS OF FIRE RATED WALLS AND FLOORS SHALL BE TESTED AND CERTIFIED AS A SYSTEM PER ASTM E814 STANDARDS FOR FIRE TESTS OF
- 10. ALL WELDING SHALL BE ACCORDING TO AMERICAN WELDING SOCIETY STANDARDS. CONTRACTOR SHALL FURNISH TO THE ARCHITECT/ENGINEER CERTIFICATES QUALIFYING EACH WELDER, PRIOR TO START OF WORK. THE ARCHITECT/ENGINEER RESERVES THE RIGHT TO REQUIRE QUALIFYING DEMONSTRATION, AT THE CONTRACTOR'S EXPENSE, OF ANY WELDERS ASSIGNED TO THE JOB.
- 11. CONTRACTOR SHALL REMOVE AND REINSTALL ALL CEILING TILES AS REQUIRED FOR THE EXECUTION OF ELECTRICAL WORK THAT IS OUTSIDE THE CONTRACT LIMITS OF CONSTRUCTION. CONTRACTOR SHALL REPLACE CEILING TILES WITH IDENTICAL MATERIAL WHERE DAMAGED BY THIS CONTRACTOR.

INSTALLATION NOTES:

THROUGH-PENETRATION FIRESTOPS, SEE SECTION 07.84.00.

- 1. CERTAIN AREAS INDICATED ON THE DRAWINGS REQUIRE OFF-SHIFT WORK HOURS. CONTRACTOR SHALL COORDINATE OFF PEAK HOURS WITH COTR TO SCHEDULE WORK HOURS. CONTRACTOR SHALL WORK ON ONE ROOM AT A TIME.
- 2. CONTRACTOR SHALL PROVIDE PROTECTION OVER COMPUTER STACKS AND DEVICES FROM DUST AND DEBRIS.
- 3. EXISTING FIRE ALARM SYSTEM SHALL REMAIN IN OPERATION UNTIL NEW FIRE ALARM SYSTEM HAS BEEN INSTALLED AND TESTED. DISCONNECT AND REMOVE OLD FIRE ALARM SYSTEM
- ASSOCIATED DEVICES, WIRING AND CONDUIT AFTER NEW SYSTEM HAS BEEN IN OPERATION.
- 4. CONTRACTOR SHALL PROVIDE AND INSTALL LABELS FOR EACH FIRE ALARM DEVICE BOX AND ON THE OUTSIDE OF THE DEVICE. THE LABELS SHALL INDICATE DEVICE ADDRESS AND TYPED SHALL BE WHITE WITH RED LETTERING.
 5. SUGGESTED CONDUIT ROUTING SHOWN ON DOCUMENTS IS ONLY A SUGGESTION BASED UPON FIELD VERIFIED CONGESTED CORRIDOR CEILING SPACES.

APPLICABLE CODES:

CONTRACTOR SHALL COMPLY WITH APPLICABLE CODES AND LOCAL AMENDMENTS. ILLINOIS AUTHORITIES HAVING JURISDICTION

ELECTRIC CODE:

NATIONAL FIRE CODE:

LIFE SAFETY CODE:

MODEL ENERGY CODE:

V.A STANDARD:

ILLINOIS BUILDING CODE

NEC 2008 EDITION
2006 EDITION
NFPA 101 2009 EDITION
IEEC 2006
CURRENT ISSUE
CURRENT ISSUE

ENGINEERING
CONSULTANTS

Experience you can build on.

231 SOUTH LASALLE
SUITE 600
CHICAGO, IL 60606
312.294.0501 FAX:
312.294.0003
www.kjww.com

STRUCTURAL | MECHANICAL | ELECTRICAL
TECHNOLOGY | MEDICAL EQUIPMENT SOLUTIONS

VA Hines Bldg. 215 New Fire Alarm System CONTRACT # VA69DP-0769A TASK ORDER # 2 HINES, ILLINOIS

200 WEST JACKSON BOULEVARD
SUITE 1200
CHICAGO, IL 60606
312.294.0501 FAX: 312.294.0003
Www.kjww.com
PROJECT # 11.0463.00

KJWW ENGINEERING RESERVES PROPRIETARY RIGHTS, INCLUDING COPYRIGHTS,
TO THIS DRAWING AND THE DATA SHOWN THEREON. SAID DRAWING AND/OR
DATA ARE THE EXCLUSIVE PROPERTY OF KJWW ENGINEERING AND SHALL NOT
BE USED OR REPRODUCED FOR ANY OTHER PROJECT WITHOUT THE EXPRESS WRITTEN
APPROVAL AND PARTICIPATION OF KJWW ENGINEERING. © 2009 KJWW, P.C.

REFERENCE SCALE IN INCHES

11 FAX: 312.294.0003
om
11.0463.00
NCLUDING COPYRIGHTS,
SAID DRAWING AND/OR
ERING AND SHALL NOT
JT THE EXPRESS WRITTEN
© 2009 KJWW, P.C.

3

04.06.12 ISSUED FOR FINAL REVIEW

KJWW ENGINEERING RESERVES PROPRIETARY RIGHTS, INCLUDING COPYRIGHTS, TO THIS DRAWING AND THE DATA SHOWN THEREON. SAID DRAWING AND/OR DATA ARE THE EXCLUSIVE PROPERTY OF KJWW ENGINEERING AND SHALL NOT BE USED OR REPRODUCED FOR ANY OTHER PROJECT WITHOUT THE EXPRESS WRITTEN APPROVAL AND PARTICIPATION OF KJWW ENGINEERING.

REFERENCE SCALE IN INCHES

0 1 2

03.30.2012


DATE REVISION DESCRIPTION

ESIGNED BY DRAWN BY

ELECTRICAL COVER

11.0463.00

SHEET DESCRIPTION

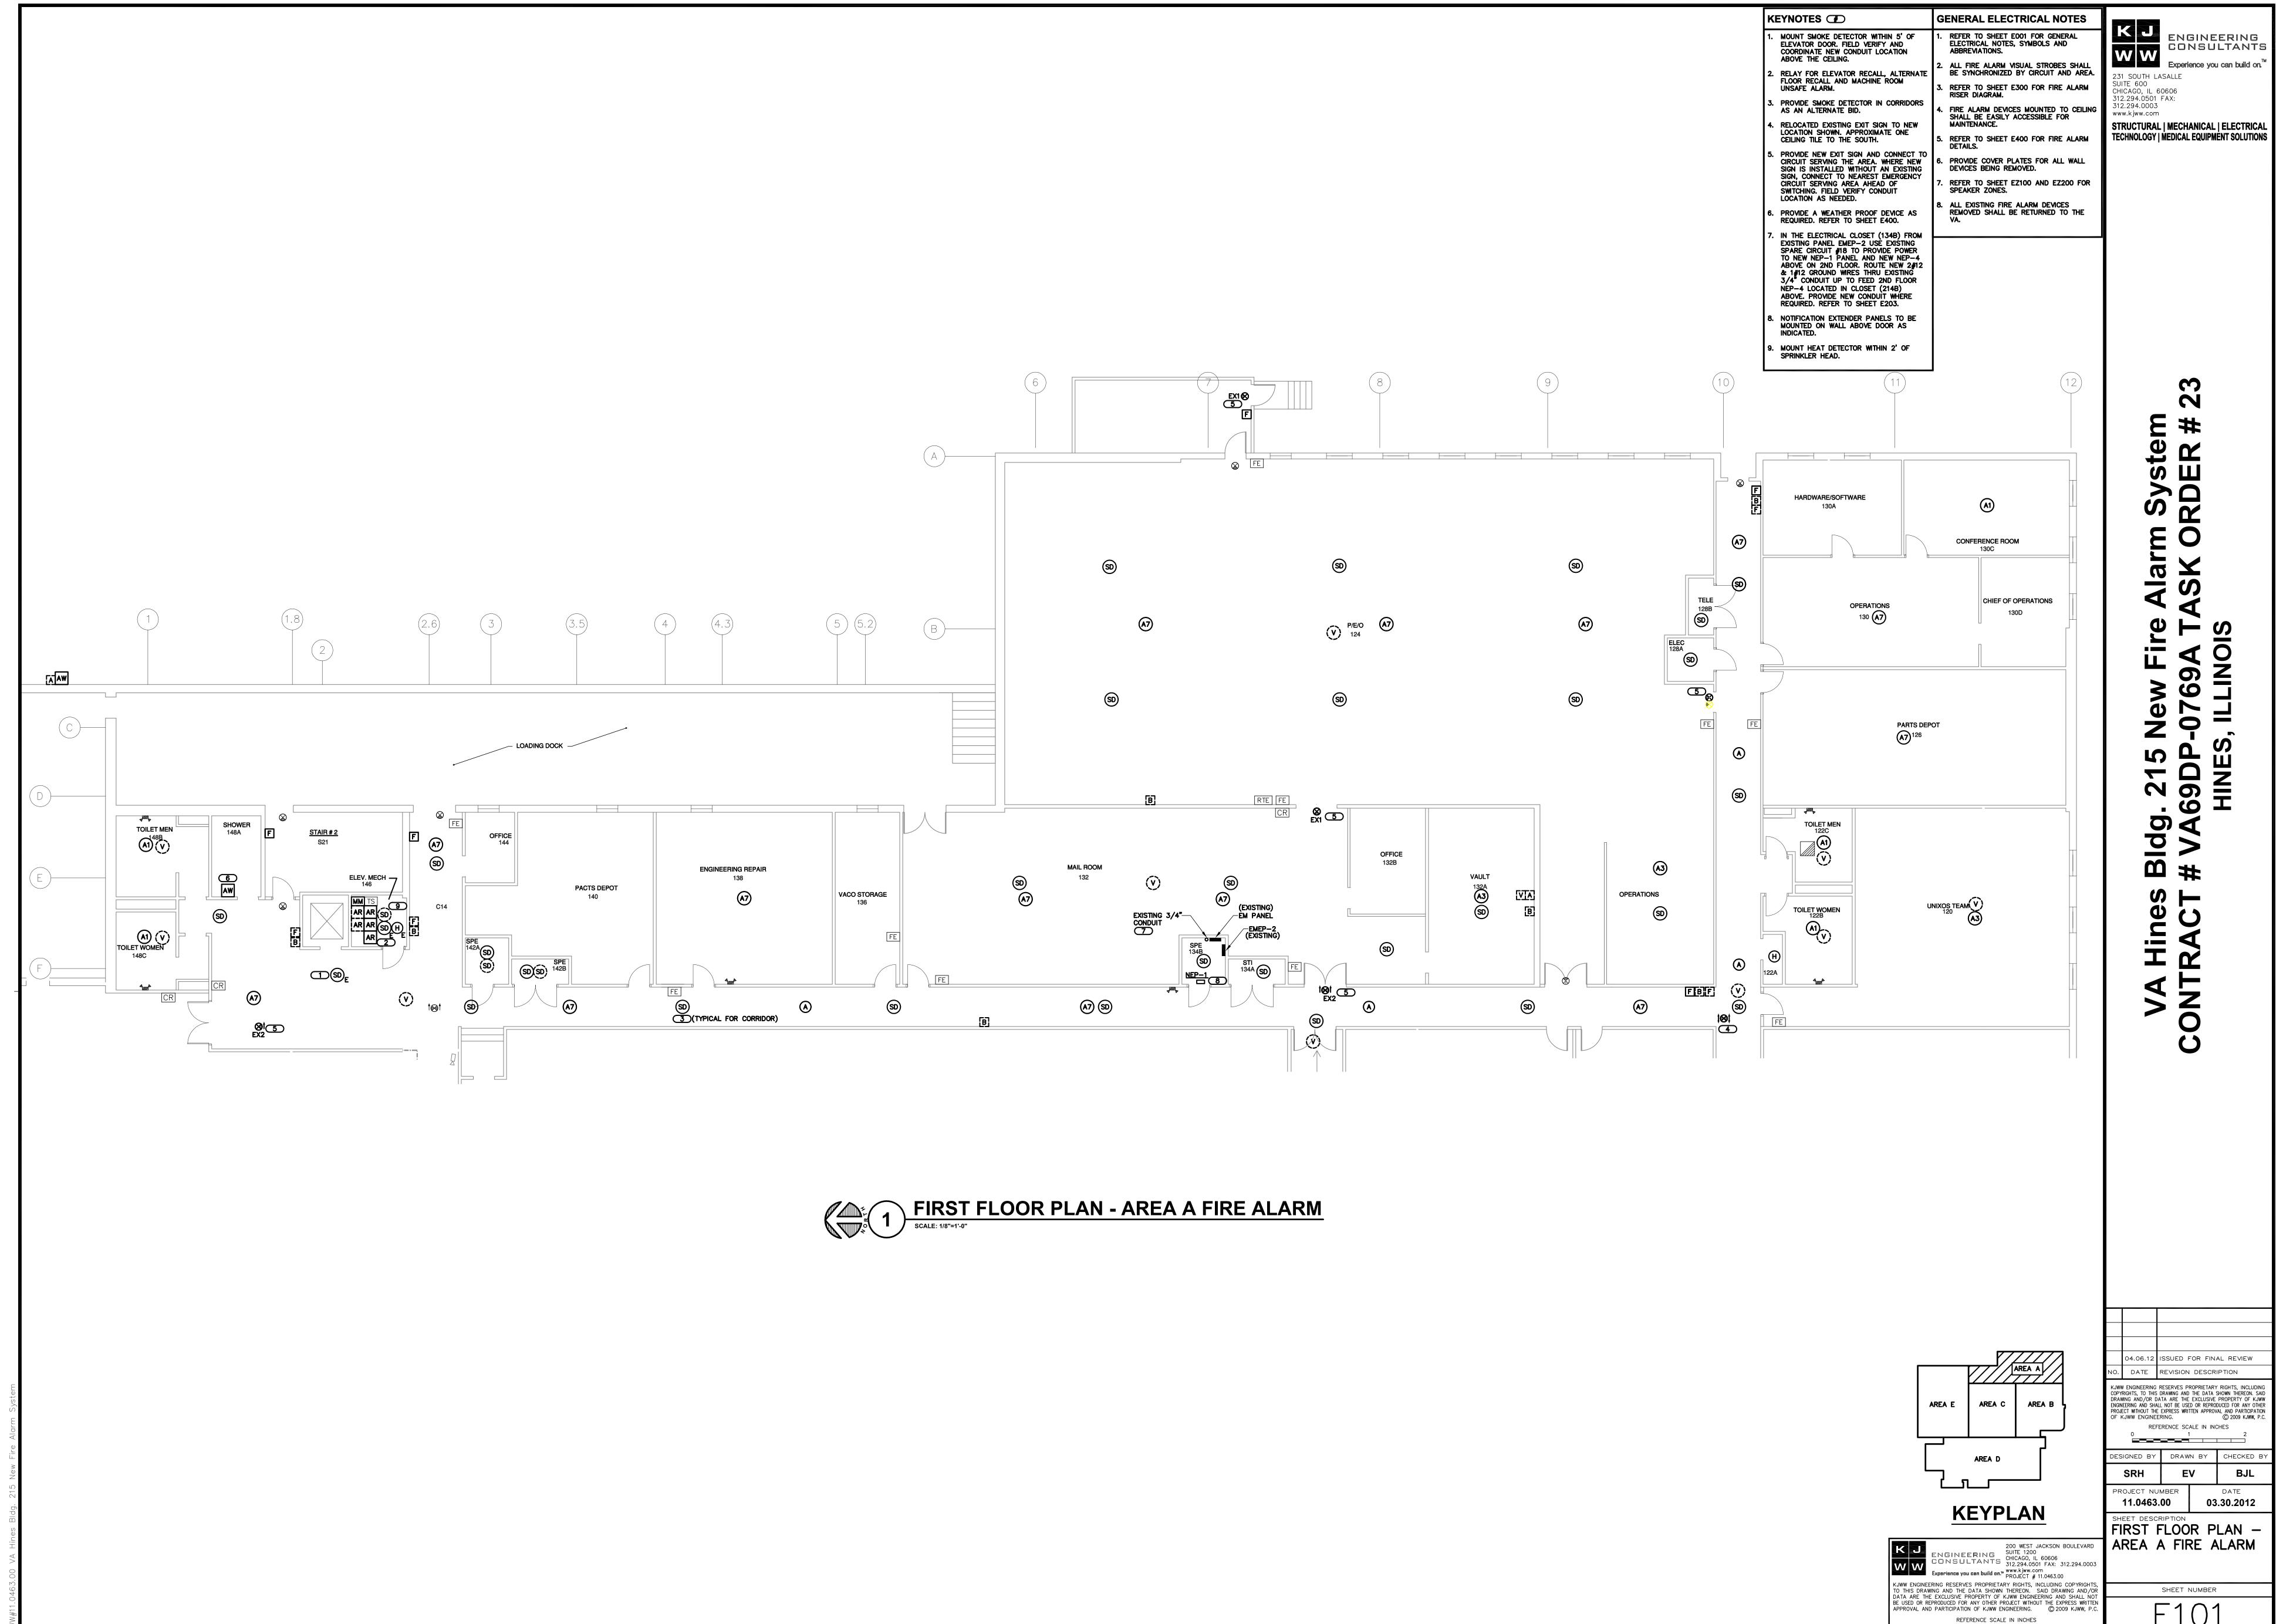



FIRST FLOOR PLAN - AREA B FIRE ALARM

SCALE: 1/8"=1'-0"



- REFER TO SHEET E001 FOR GENERAL ELECTRICAL NOTES, SYMBOLS AND ABBREVIATIONS.
- 2. ALL FIRE ALARM VISUAL STROBES SHALL BE SYNCHRONIZED BY CIRCUIT AND AREA. 3. REFER TO SHEET E300 FOR FIRE ALARM RISER DIAGRAM.
- 4. FIRE ALARM DEVICES MOUNTED TO CEILING SHALL BE EASILY ACCESSIBLE FOR MAINTENANCE.
- 5. REFER TO SHEET E400 FOR FIRE ALARM DETAILS.
- 6. PROVIDE COVER PLATES FOR ALL WALL DEVICES BEING REMOVED.
- 7. REFER TO SHEET EZ100 AND EZ200 FOR SPEAKER ZONES. B. ALL EXISTING FIRE ALARM DEVICES
 REMOVED SHALL BE RETURNED TO THE

KEYNOTES

- . PROVIDE SMOKE DETECTOR IN CORRIDORS AS AN ALTERNATE BID. 2. EXTEND EXISTING CAT6 DATA CONNECTION FOR INTERNET DIAGNOSTIC CAPABILITY TO NEW FAP-1.
- 3. PATCH AND FINISH WALL AFTER EXISTING ANNUNCIATOR PANEL HAS BEEN REMOVED AND NEW FIRE ALARM PANEL INSTALLED. PROVIDE A TEMPORARY SUPPORT BOARD FOR THE EXISTING FIRE ALARM ANNUNCIATOR DURING INSTALLATION OF THE NEW FIRE ALARM PANEL.
- 4. EXISTING FIRE ALARM CONTROL PANELS
 AND ALL ASSOCIATED CONDUIT AND WIRE
 THROUGHOUT THE BUILDING TO BE
 REMOVED AND DISPOSED OF AFTER THE
 NEW FIRE ALARM SYSTEM IS TESTED AND
 ACCEPTED.
- 5. PROVIDE NEW FIRE ALARM CONTROL PANEL IN THE SAME LOCATION AS THE EXISTING ANNUNCIATOR. FIRE FIGHTER MICROPHONE PROVIDED WITH NEW FIRE ALARM PANEL.
- 3. PROVIDE NEW EMERGENCY LIGHTING UNIT AND CONNECT TO EXISTING CIRCUIT FOR THE LOCAL LIGHTING.
- 7. PROVIDE NEW EXIT SIGN AND CONNECT TO CIRCUIT SERVING THE AREA. FIELD VERIFY CONDUIT LOCATION AS NEEDED.
- BUILDING #1 TO EXISTING FACE PANEL IN BUILDING #215 AND EXTEND (4) FOUR FIBER CABLES TO NEW FACP PANEL LOCATION. PROVIDE 3/4" CONDUIT AND FIELD VERIFY CONDUIT ROUTE. PROVIDE FIBER OPTIC SPLICE BOX AND NEW FIBER CABLES IF LENGTH OF EXISTING FIBER WILL NOT REACH TO NEW PANEL.

2 Sy RD 0

ENGINEERING CONSULTANTS


Experience you can build on."

STRUCTURAL | MECHANICAL | ELECTRICAL TECHNOLOGY | MEDICAL EQUIPMENT SOLUTIONS


31 SOUTH LASALLE

CHICAGO, IL 60606 312.294.0501 FAX: 312.294.0003

www.kjww.com

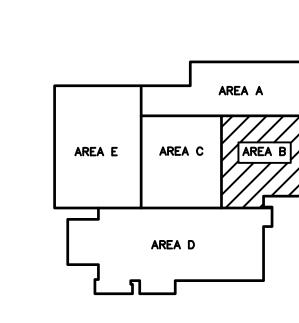

KEYPLAN

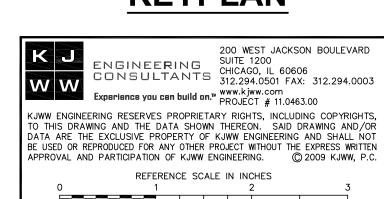

SHEET DESCRIPTION
FIRST FLOOR PLAN -AREA B FIRE ALARM SHEET NUMBER

PROJECT NUMBER

11.0463.00

KJWW ENGINEERING RESERVES PROPRIETARY RIGHTS. INCLUDING

KJWW ENGINEERING RESERVES PROPRIETARY RIGHTS, INCLUDING COPYRIGHTS, TO THIS DRAWING AND THE DATA SHOWN THEREON. SAID DRAWING AND/OR DATA ARE THE EXCLUSIVE PROPERTY OF KJWW ENGINEERING AND SHALL NOT BE USED OR REPRODUCED FOR ANY OTHER PROJECT WITHOUT THE EXPRESS WRITTEN APPROVAL AND PARTICIPATION OF KJWW ENGINEERING.


REFERENCE SCALE IN INCHES

EV

DRAWN BY CHECKED BY

BJL

03.30.2012

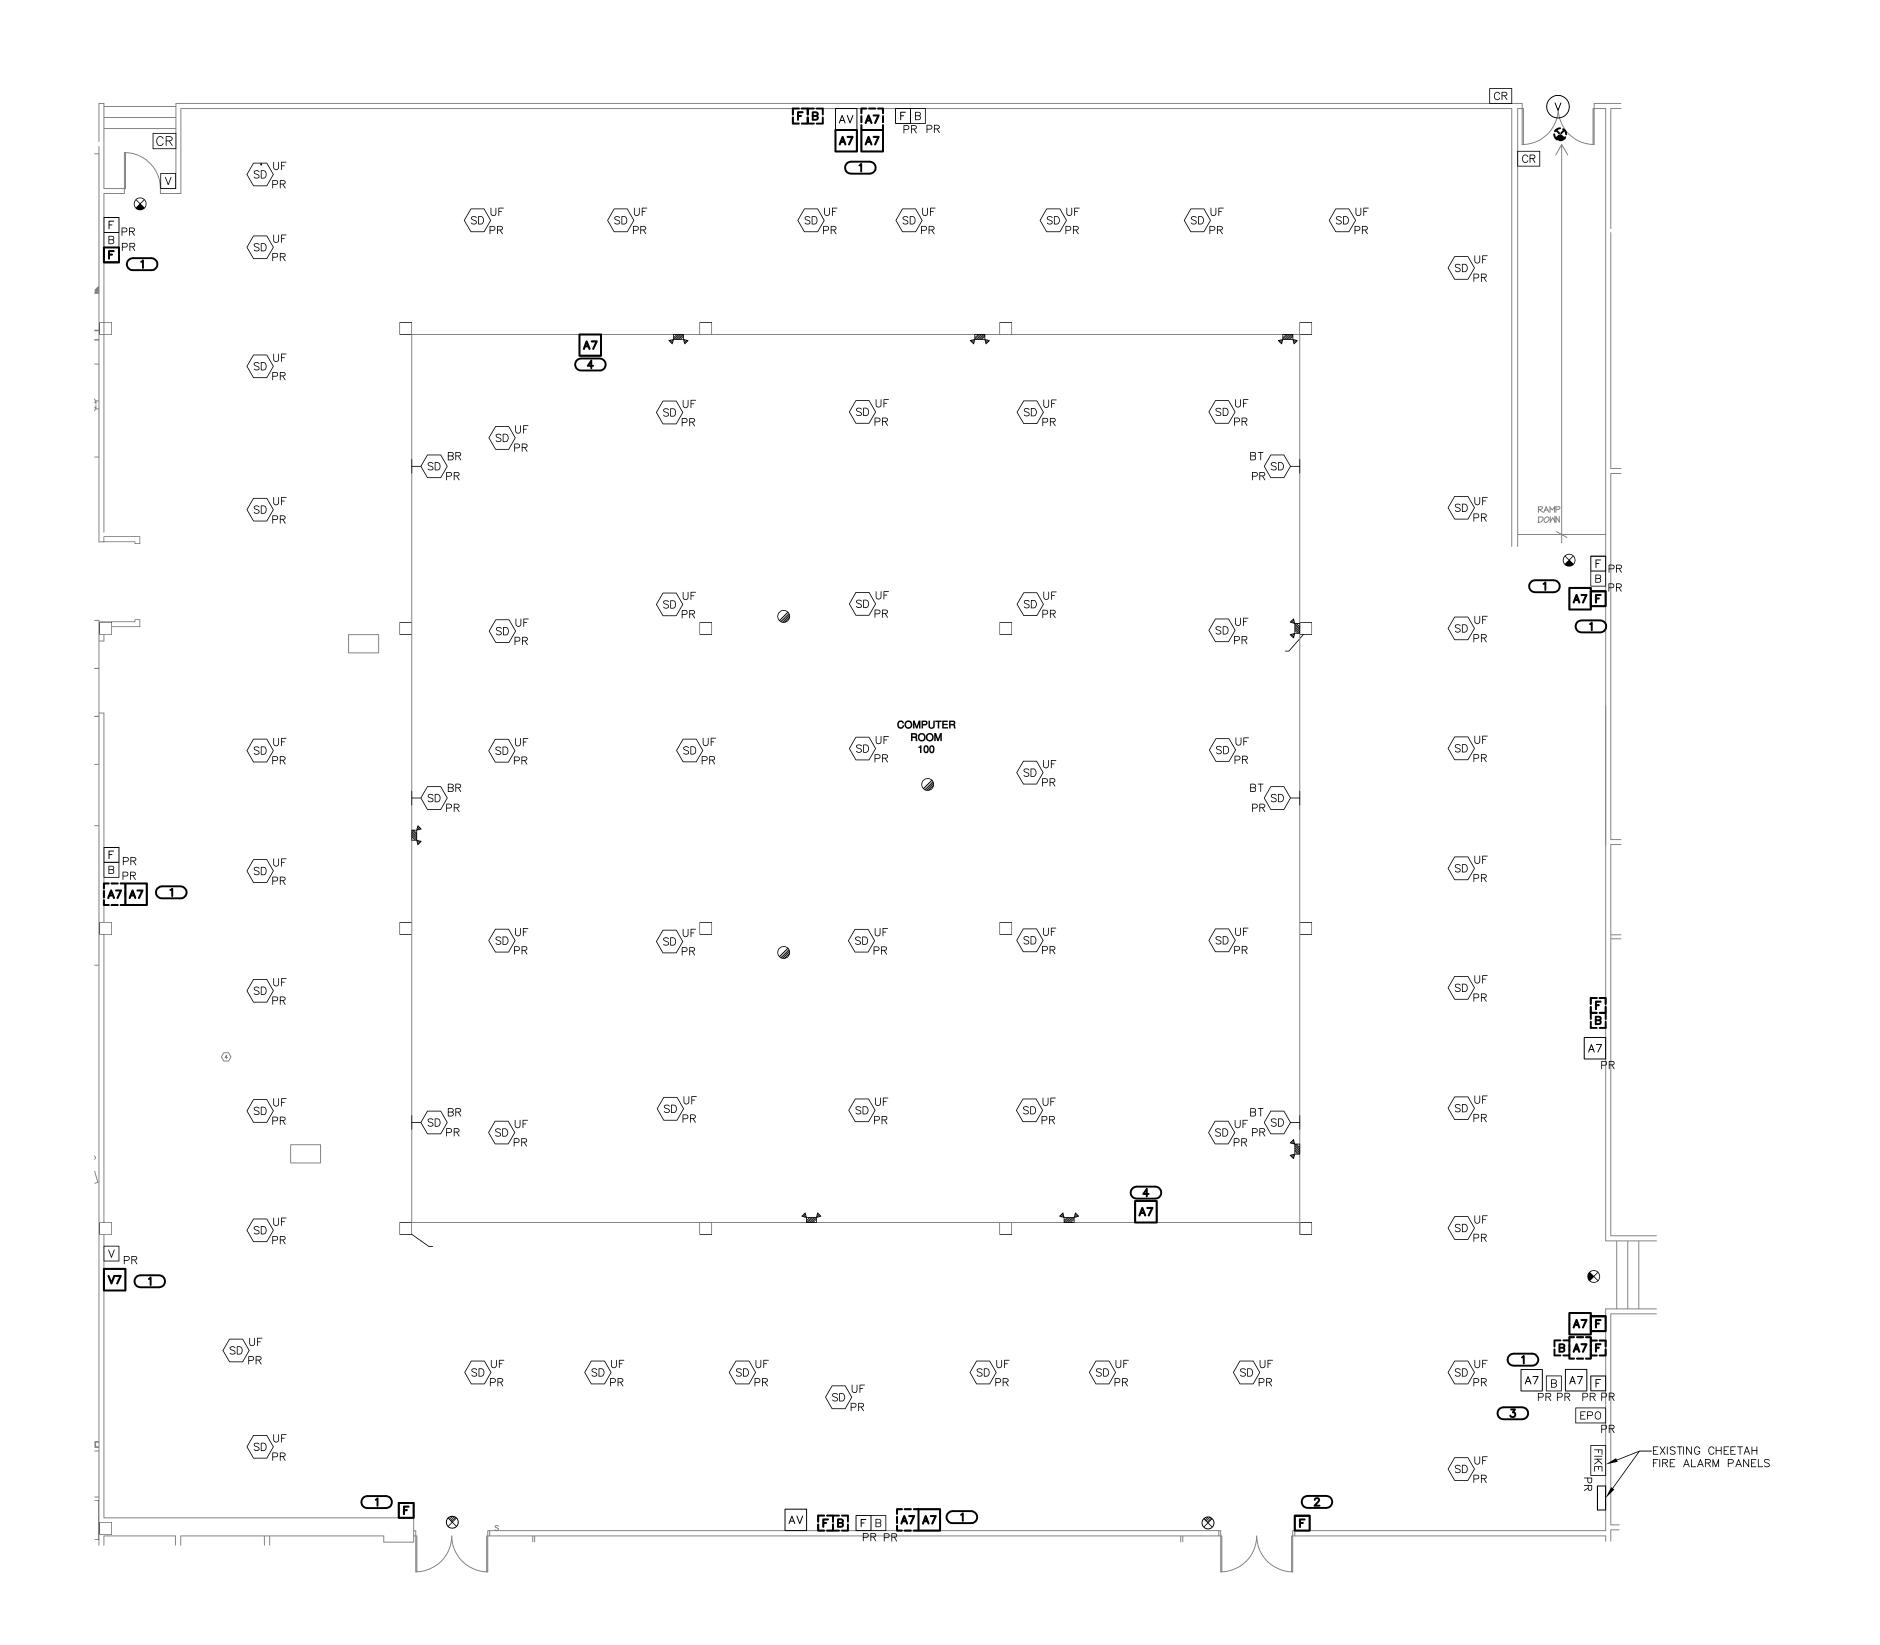

FIRST FLOOR PLAN - AREA C FIRE ALARM

SCALE: 1/8"=1'-0"

GENERAL ELECTRICAL NOTES

I. REFER TO SHEET E001 FOR GENERAL ELECTRICAL NOTES, SYMBOLS AND ABBREVIATIONS.

ENGINEERING CONSULTANTS

Experience you can build on."

STRUCTURAL | MECHANICAL | ELECTRICAL TECHNOLOGY | MEDICAL EQUIPMENT SOLUTIONS

0

1. 215 I 69DP-HINES,

231 SOUTH LASALLE

SUITE 600 CHICAGO, IL 60606 312.294.0501 FAX: 312.294.0003

www.kjww.com

2. ALL FIRE ALARM VISUAL STROBES SHALL BE SYNCHRONIZED BY CIRCUIT AND AREA.

6. REFER TO SHEET E300 FOR FIRE ALARM RISER DIAGRAM.

4. FIRE ALARM DEVICES MOUNTED TO CEILING SHALL BE EASILY ACCESSIBLE FOR MAINTENANCE.

i. REFER TO SHEET E400 FOR FIRE ALARM DETAILS. E. PROVIDE COVER PLATES FOR ALL WALL DEVICES BEING REMOVED.

7. REFER TO SHEET EZ100 AND EZ200 FOR SPEAKER ZONES. B. ALL EXISTING FIRE ALARM DEVICES REMOVED SHALL BE RETURNED TO THE

. CONNECT NEW SIMPLEX DEVICES WHERE INDICATED ADJACENT TO THE EXISTING SYSTEM TO BE REMOVED. THE EXISTING PRE-ACTION SUPPRESSION SYSTEM IS TO BEMAIN

KEYNOTES

2. PROVIDE NEW PULL STATION AS SHOWN AND CONNECT TO NEW SIMPLEX FAP-1.

3. REFER TO ELEVATION DETAIL 3/E400. MOUNT AT BOTTOM OF CLERESTORY WALL.

AREA C AREA E AREA D **KEYPLAN**

ENGINEERING
CUNSULTANTS

200 WEST JACKSON BOULEVARD
SUITE 1200
CHICAGO, IL 60606
312.294.0501 FAX: 312.294.0003 Experience you can build on." www.kjww.com KJWW ENGINEERING RESERVES PROPRIETARY RIGHTS, INCLUDING COPYRIGHTS, TO THIS DRAWING AND THE DATA SHOWN THEREON. SAID DRAWING AND/OR DATA ARE THE EXCLUSIVE PROPERTY OF KJWW ENGINEERING AND SHALL NOT BE USED OR REPRODUCED FOR ANY OTHER PROJECT WITHOUT THE EXPRESS WRITTEN APPROVAL AND PARTICIPATION OF KJWW ENGINEERING. © 2009 KJWW, P.C. REFERENCE SCALE IN INCHES

SHEET DESCRIPTION
FIRST FLOOR PLAN -AREA C FIRE ALARM

SHEET NUMBER

08/3/10 ISPOENDUM 1 FINAL REVIEW

KJWW ENGINEERING RESERVES PROPRIETARY RIGHTS, INCLUDING

COPYRIGHTS, TO THIS DRAWING AND THE DATA SHOWN THEREON. SAID DRAWING AND/OR DATA ARE THE EXCLUSIVE PROPERTY OF KJWW ENGINEERING AND SHALL NOT BE USED OR REPRODUCED FOR ANY OTHER PROJECT WITHOUT THE EXPRESS WRITTEN APPROVAL AND PARTICIPATION OF KJWW ENGINEERING.

REFERENCE SCALE IN INCHES

EV

DRAWN BY CHECKED BY


BJL

03.30.2012

ESIGNED BY

PROJECT NUMBER


11.0463.00

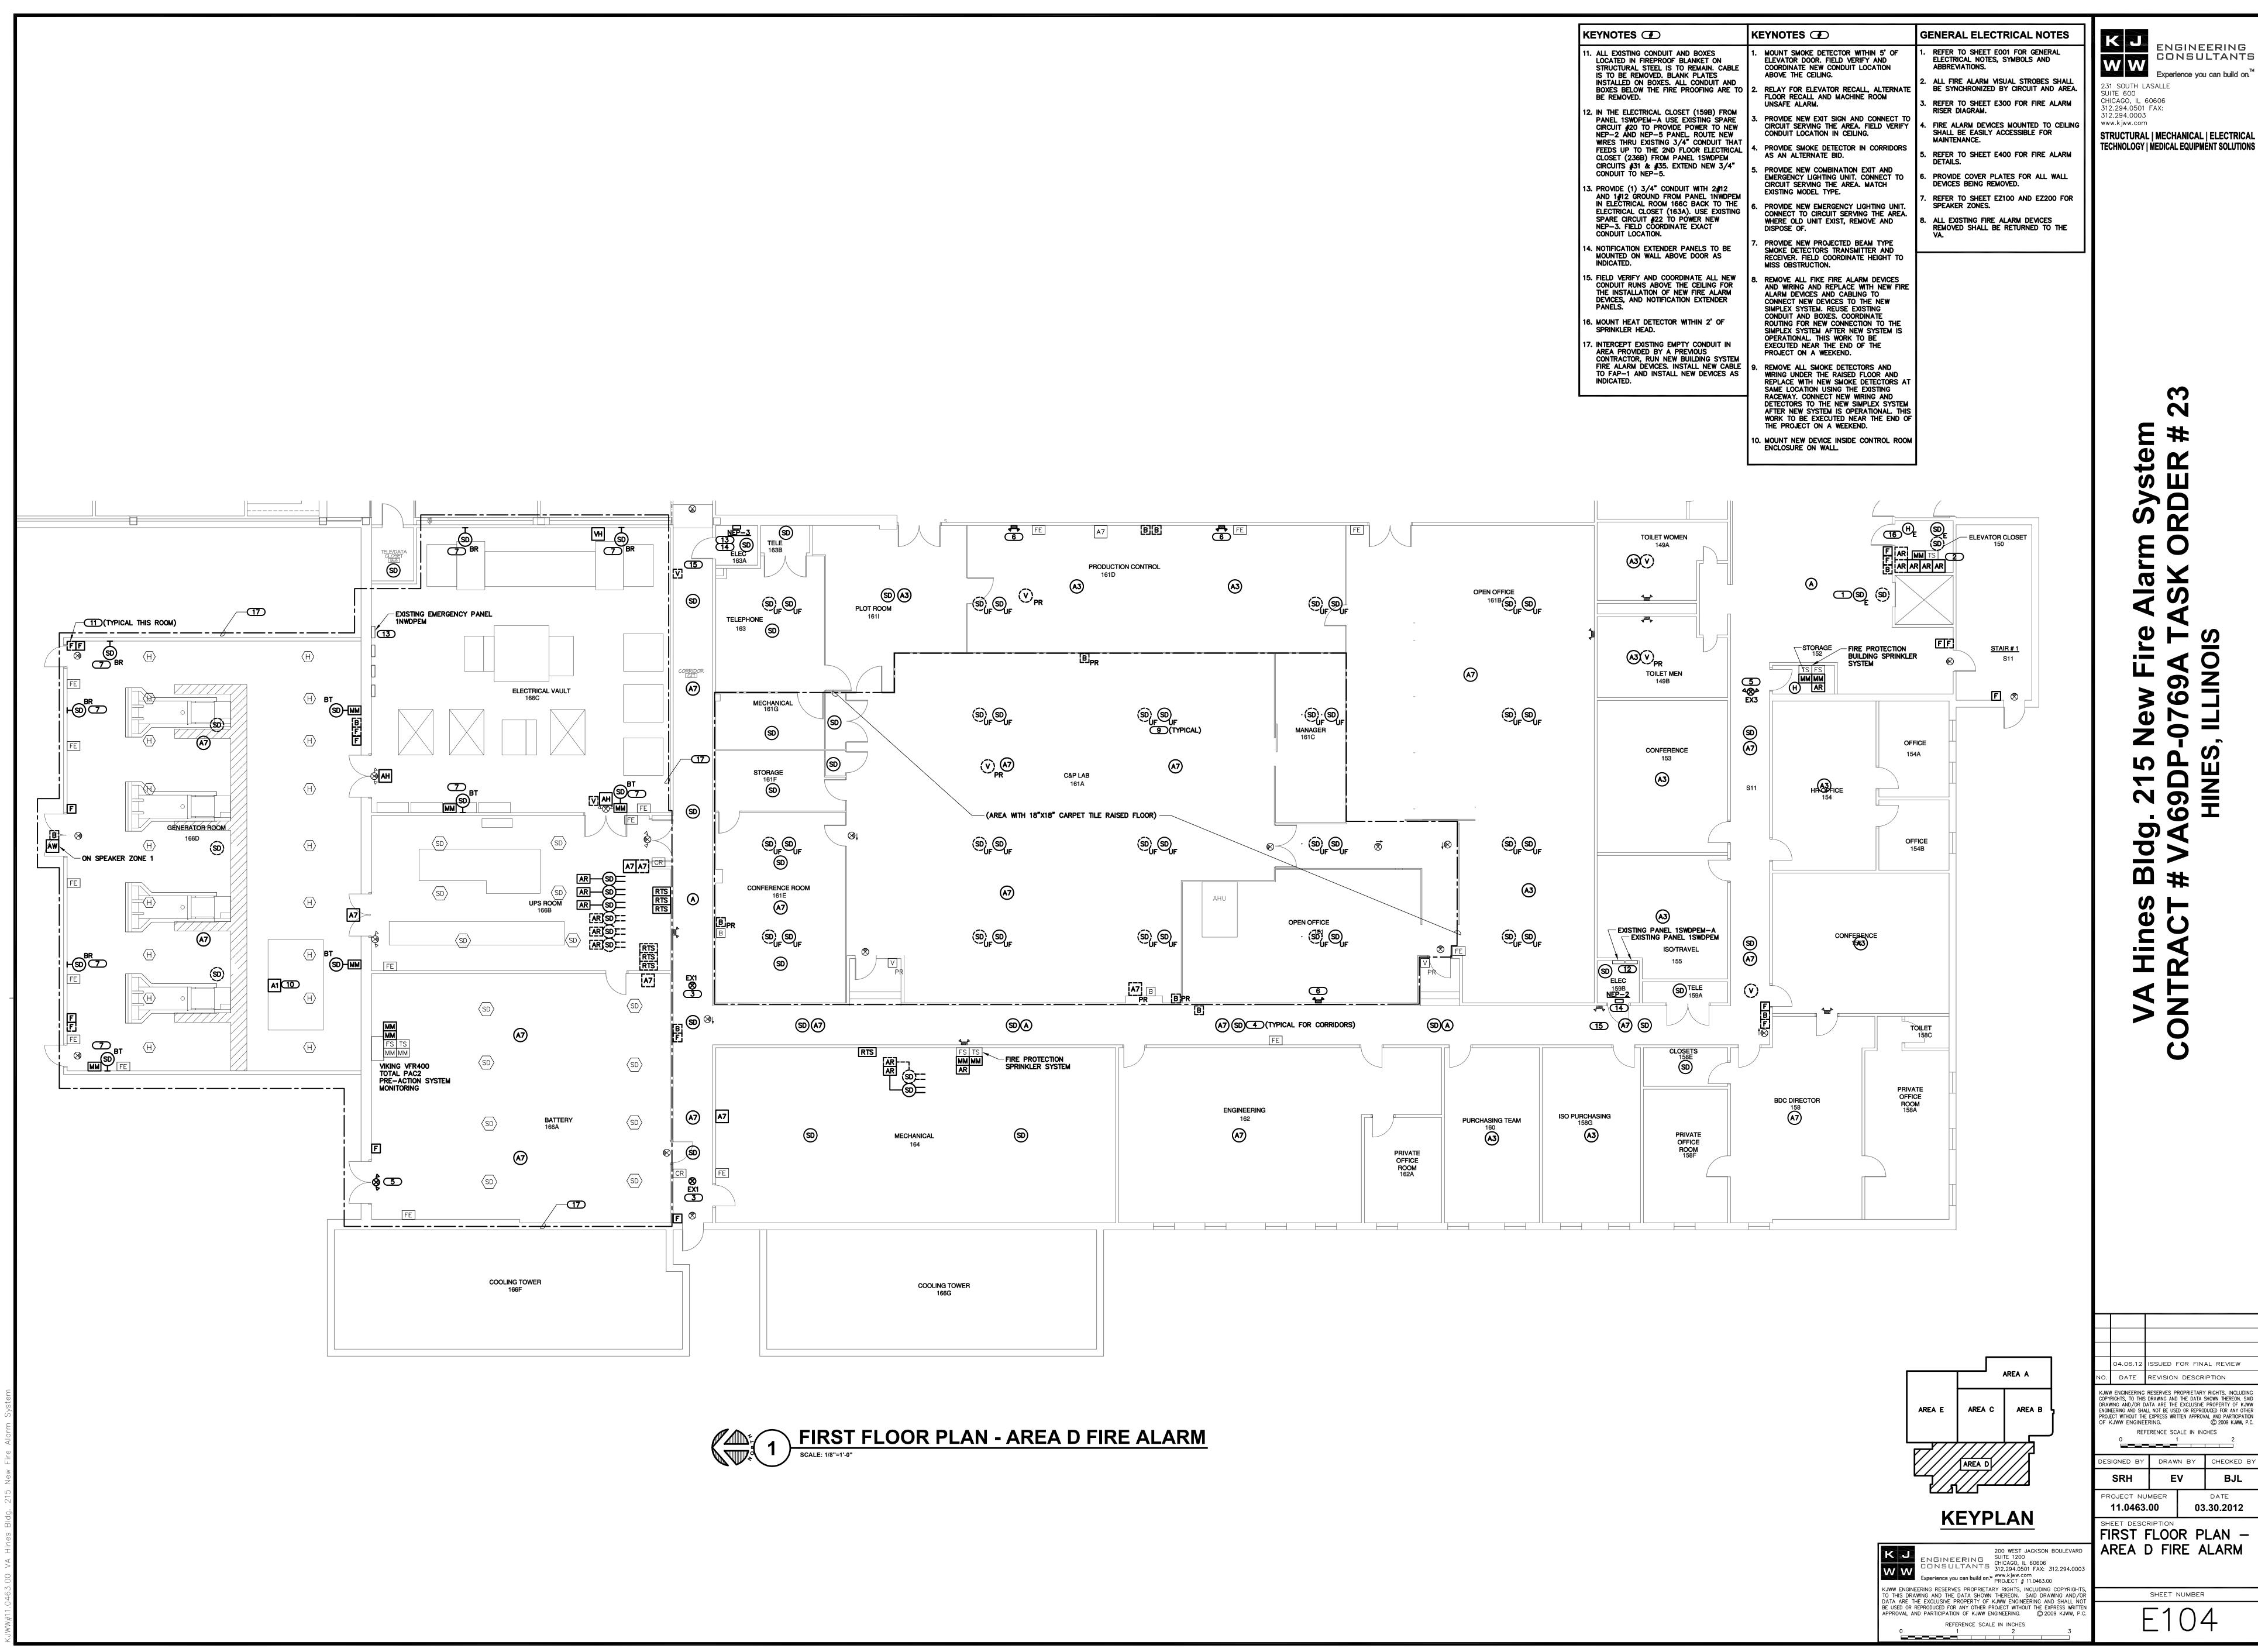

Experience you can build on. CONSULTANTS

> KJWW FNGINFFRING RESERVES PROPRIETARY RIGHTS. INCLUDIN COPYRIGHTS, TO THIS DRAWING AND THE DATA SHOWN THEREON. SAID DRAWING AND/OR DATA ARE THE EXCLUSIVE PROPERTY OF KJWW ENGINEERING AND SHALL NOT BE USED OR REPRODUCED FOR ANY OTHER PROJECT WITHOUT THE EXPRESS WRITTEN APPROVAL AND PARTICIPATION OF KJWW ENGINEERING. © 2009 KJWW, P.C REFERENCE SCALE IN INCHES 03.30.2012

FIRST FLOOR PLAN -AREA D FIRE ALARM

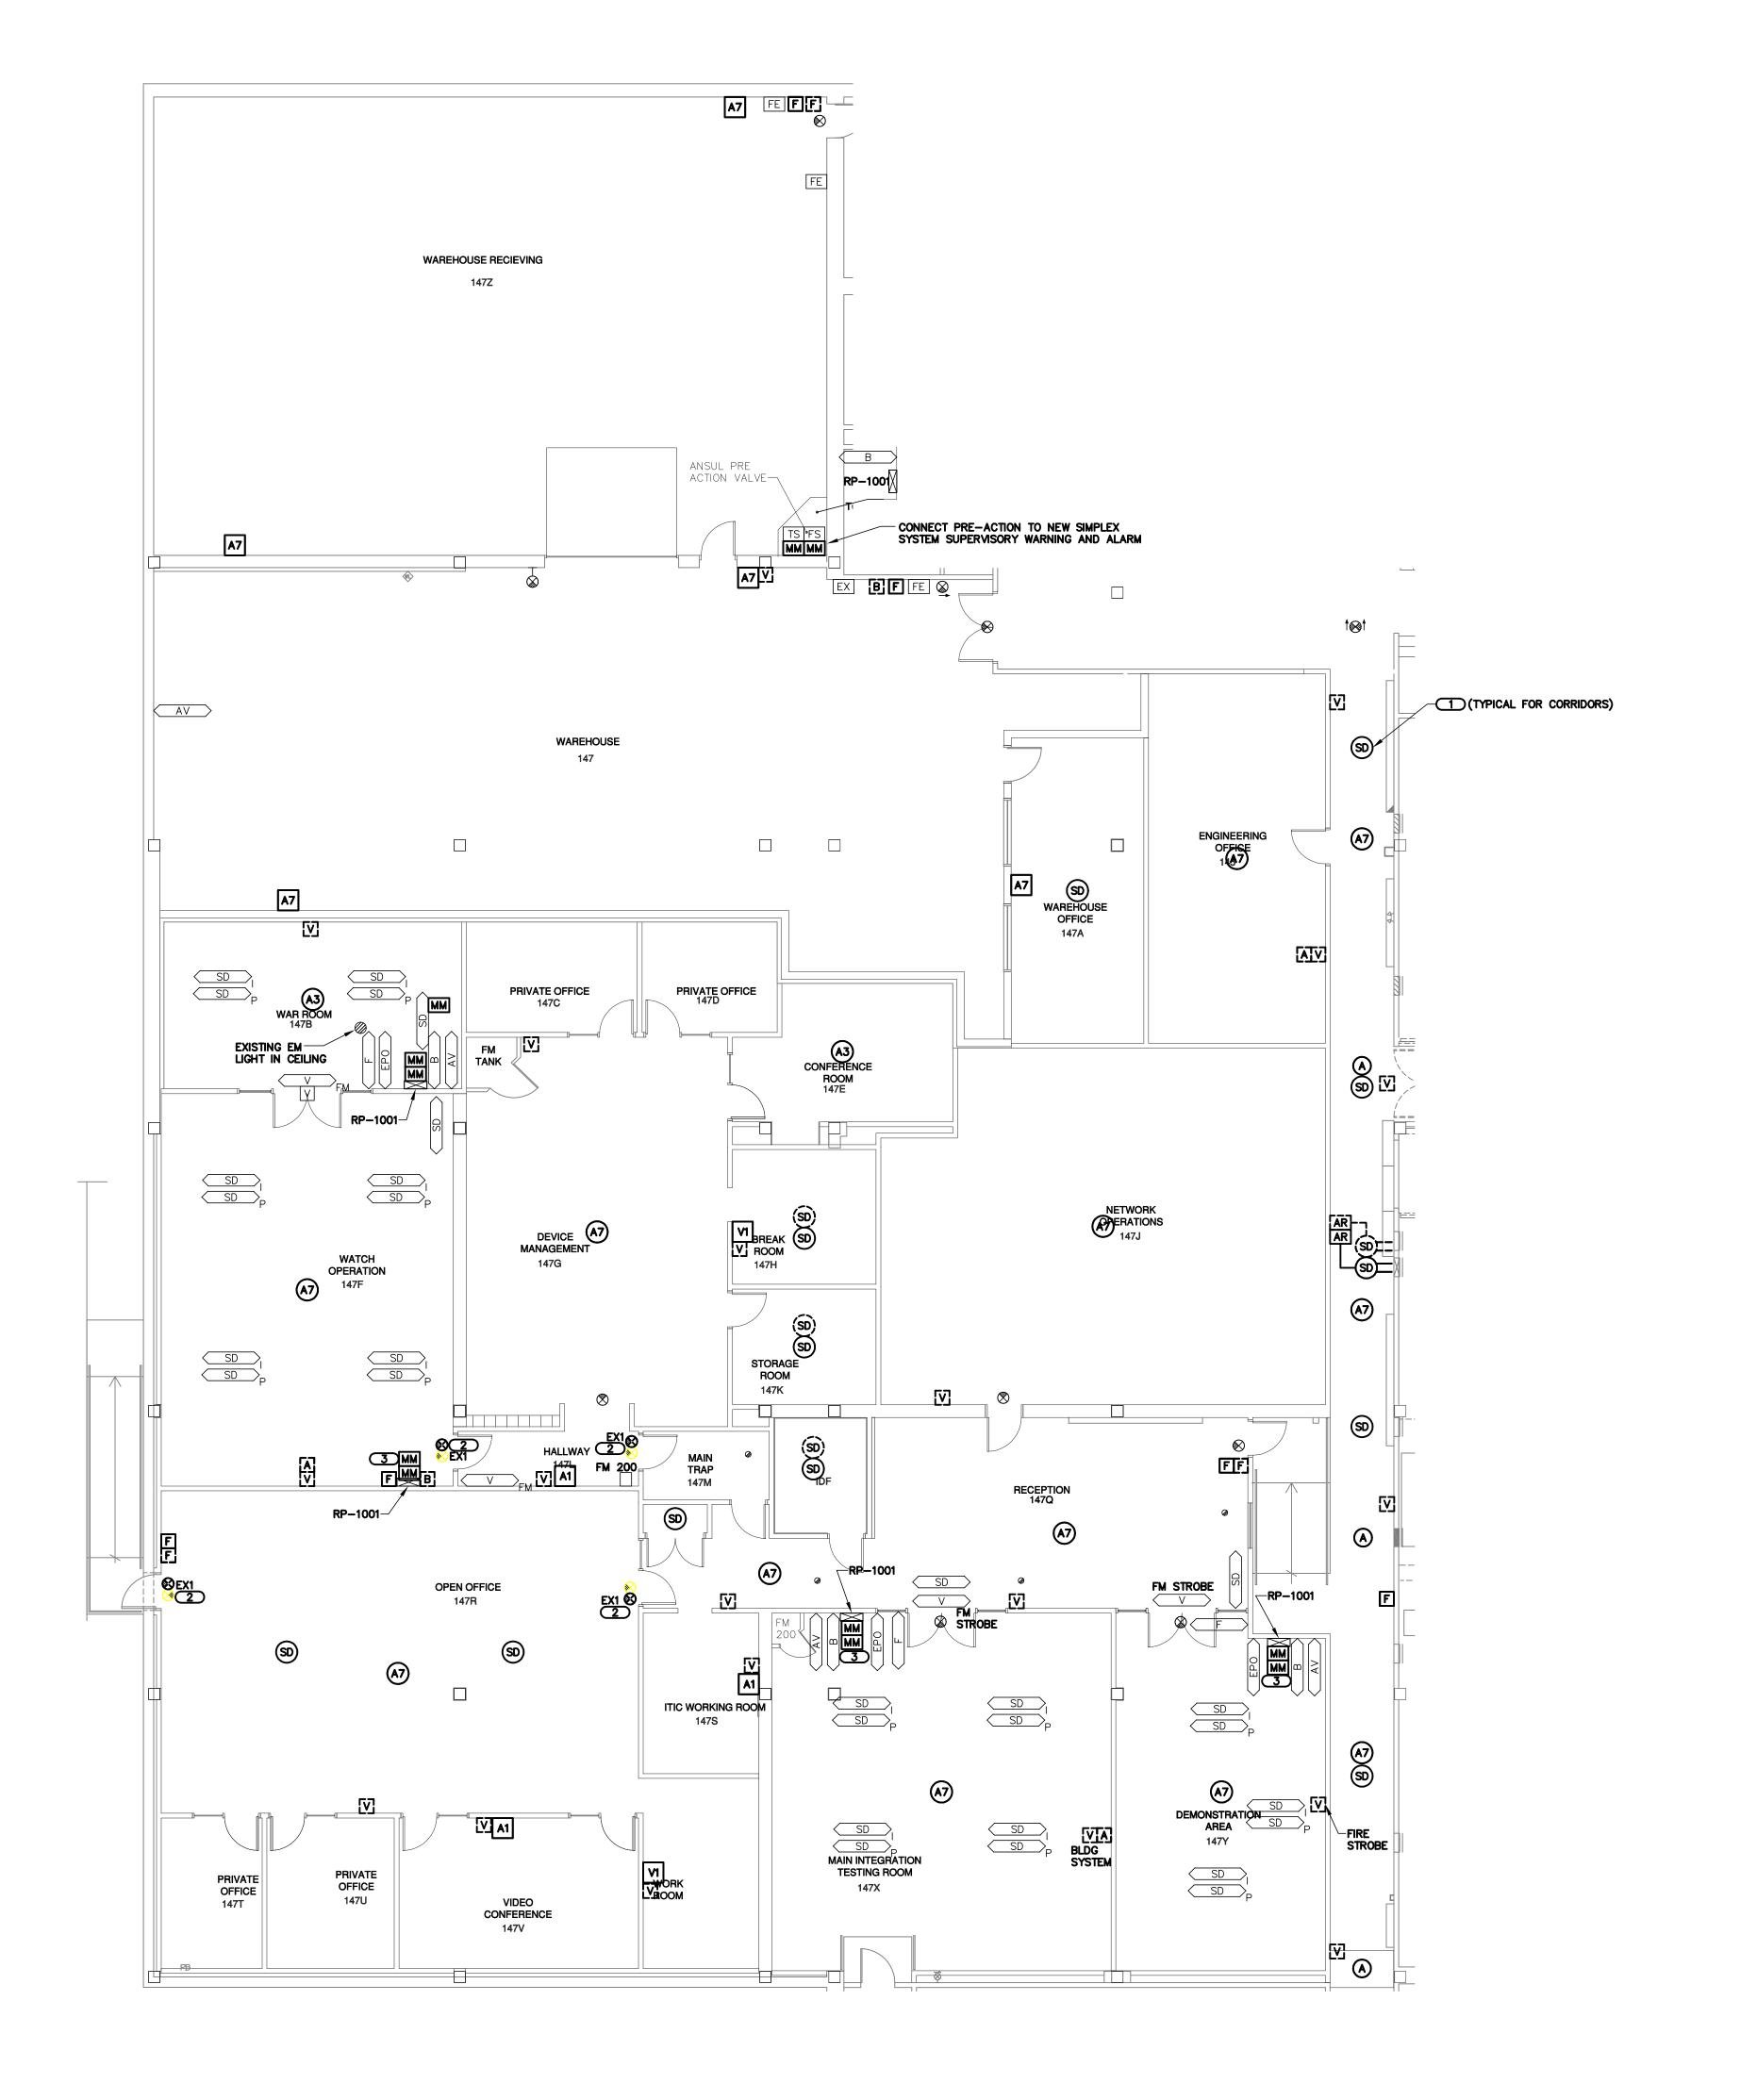

FIRST FLOOR PLAN - AREA E FIRE ALARM

SCALE: 1/8"=1'-0"

GENERAL ELECTRICAL NOTES

REFER TO SHEET E001 FOR GENERAL ELECTRICAL NOTES, SYMBOLS AND ABBREVIATIONS.

EXPERING CONSULTANTS

Experience you can build on.

STRUCTURAL | MECHANICAL | ELECTRICAL TECHNOLOGY | MEDICAL EQUIPMENT SOLUTIONS

0

231 SOUTH LASALLE

SUITE 600 CHICAGO, IL 60606 312.294.0501 FAX: 312.294.0003

www.kjww.com

. ALL FIRE ALARM VISUAL STROBES SHALL BE SYNCHRONIZED BY CIRCUIT AND AREA. 3. REFER TO SHEET E300 FOR FIRE ALARM RISER DIAGRAM.

4. FIRE ALARM DEVICES MOUNTED TO CEILING SHALL BE EASILY ACCESSIBLE FOR MAINTENANCE.

REFER TO SHEET EZ100 AND EZ200 FOR SPEAKER ZONES.

5. REFER TO SHEET E400 FOR FIRE ALARM DETAILS.

6. PROVIDE COVER PLATES FOR ALL WALL DEVICES BEING REMOVED.

ALL EXISTING FIRE ALARM DEVICES REMOVED SHALL BE RETURNED TO THE

KEYNOTES (7)

. PROVIDE SMOKE DETECTOR IN CORRIDORS AS AN ALTERNATE BID.

2. PROVIDE NEW EXIT SIGN AND CONNECT TO EMERGENCY CIRCUIT SERVING THE AREA. FIELD VERIFY CONDUIT LOCATION AS

3. PROVIDE ADDRESSABLE MONITOR MODULES AT FM200 PANELS AS NEEDED. CONNECT TO EXISTING WIRING TO EXISTING FIRE ALARM PANEL. EXTEND WIRING TO NEW FAP—1.

KJWW ENGINEERING RESERVES PROPRIETARY RIGHTS INCLUDING COPYRIGHTS, TO THIS DRAWING AND THE DATA SHOWN THEREON. SAID DRAWING AND/OR DATA ARE THE EXCLUSIVE PROPERTY OF KJWW ENGINEERING AND SHALL NOT BE USED OR REPRODUCED FOR ANY OTHER PROJECT WITHOUT THE EXPRESS WRITTEN APPROVAL AND PARTICIPATION OF KJWW ENGINEERING. AREA B REFERENCE SCALE IN INCHES ESIGNED BY DRAWN BY CHECKED BY

AREA E

AREA C

AREA D

KEYPLAN

KJWW ENGINEERING RESERVES PROPRIETARY RIGHTS, INCLUDING COPYRIGHTS, TO THIS DRAWING AND THE DATA SHOWN THEREON. SAID DRAWING AND/OR DATA ARE THE EXCLUSIVE PROPERTY OF KJWW ENGINEERING AND SHALL NOT BE USED OR REPRODUCED FOR ANY OTHER PROJECT WITHOUT THE EXPRESS WRITTEN APPROVAL AND PARTICIPATION OF KJWW ENGINEERING. © 2009 KJWW, P.C.

REFERENCE SCALE IN INCHES


EV PROJECT NUMBER 11.0463.00 SHEET DESCRIPTION
FIRST FLOOR PLAN -AREA E FIRE ALARM ENGINEERING
CONSULTANTS

200 WEST JACKSON BOULEVARD
SUITE 1200
CHICAGO, IL 60606
312.294.0501 FAX: 312.294.0003 Experience you can build on. www.kjww.com

SHEET NUMBER

BJL

03.30.2012

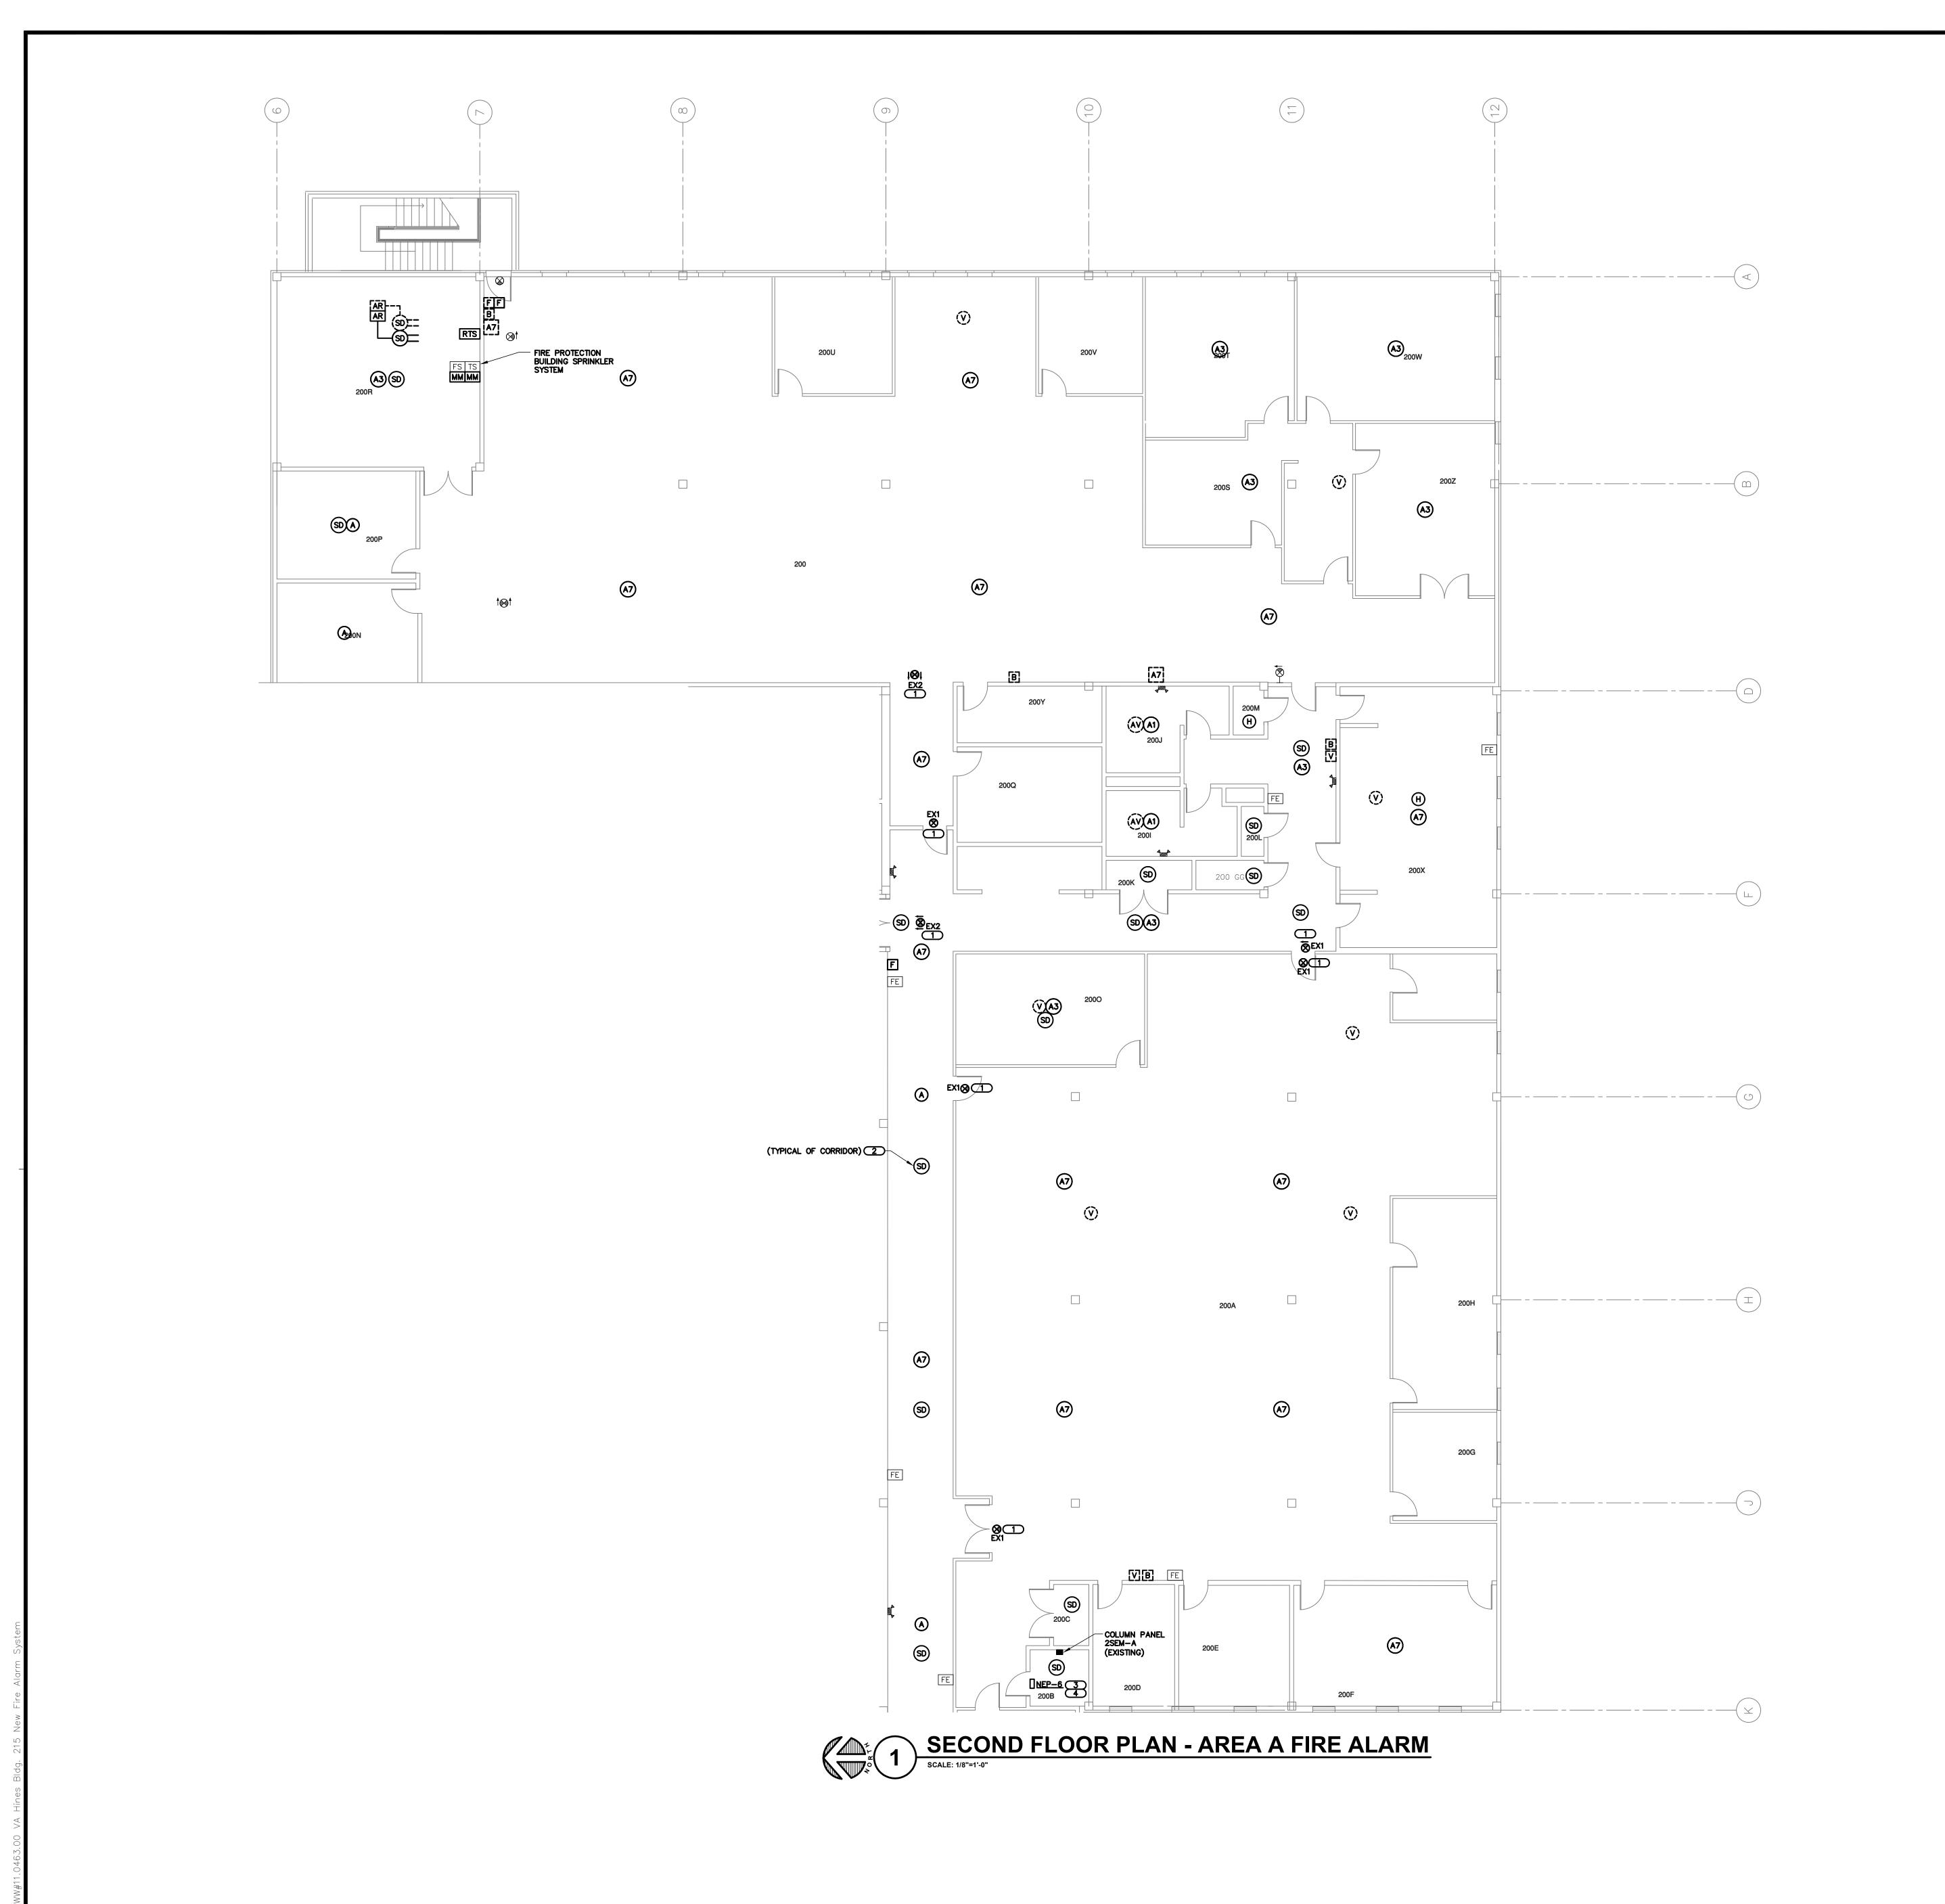

GENERAL ELECTRICAL NOTES

1. REFER TO SHEET E001 FOR GENERAL ELECTRICAL NOTES, SYMBOLS AND ABBREVIATIONS.

. ALL FIRE ALARM VISUAL STROBES SHALL BE SYNCHRONIZED BY CIRCUIT AND AREA.

3. REFER TO SHEET E300 FOR FIRE ALARM RISER DIAGRAM.

4. FIRE ALARM DEVICES MOUNTED TO CEILING SHALL BE EASILY ACCESSIBLE FOR MAINTENANCE.

. REFER TO SHEET E400 FOR FIRE ALARM DETAILS. . PROVIDE COVER PLATES FOR ALL WALL DEVICES BEING REMOVED.

. REFER TO SHEET EZ100 AND EZ200 FOR SPEAKER ZONES. 3. ALL EXISTING FIRE ALARM DEVICES REMOVED SHALL BE RETURNED TO THE VA.

KEYNOTES

PROVIDE NEW EXIT SIGN AND CONNECT TO CIRCUIT SERVING THE AREA. FIELD VERIFY THAT MAXIMUM OF 15 EXIT SIGNS SHALL BE CONNECTED TO THE CIRCUIT.

. PROVIDE SMOKE DETECTOR IN CORRIDORS AS AN ALTERNATE BID. 3. PROVIDE (1) 3/4" CONDUIT WITH 2#12
AND 1#12 GROUND FROM PANEL 2SEM-A
IN ELECTRICAL CLOSET (2008). USE
EXISTING SPARE CIRCUIT #18 TO POWER
NEW NEP-6. COORDINATE EXACT CONDUIT
LOCATION.

4. NOTIFICATION EXTENDER PANELS TO BE MOUNTED ON WALL ABOVE DOOR AS INDICATED.

Experience you can build on.

STRUCTURAL | MECHANICAL | ELECTRICAL TECHNOLOGY | MEDICAL EQUIPMENT SOLUTIONS

231 SOUTH LASALLE

SUITE 600 CHICAGO, IL 60606 312.294.0501 FAX: 312.294.0003

www.kjww.com

0

AREA B

KEYPLAN

ENGINEERING
CONSULTANTS

200 WEST JACKSON BOULEVARD
SUITE 1200
CHICAGO, IL 60606
312.294.0501 FAX: 312.294.0003 Experience you can build an.™ www.kjww.com
PROJECT # 11.0463.00 KJWW ENGINEERING RESERVES PROPRIETARY RIGHTS, INCLUDING COPYRIGHTS, TO THIS DRAWING AND THE DATA SHOWN THEREON. SAID DRAWING AND/OR DATA ARE THE EXCLUSIVE PROPERTY OF KJWW ENGINEERING AND SHALL NOT BE USED OR REPRODUCED FOR ANY OTHER PROJECT WITHOUT THE EXPRESS WRITTEN APPROVAL AND PARTICIPATION OF KJWW ENGINEERING. © 2009 KJWW, P.C. REFERENCE SCALE IN INCHES

ALARM SHEET NUMBER

AREA A FIRE

PROJECT NUMBER 11.0463.00

SHEET DESCRIPTION

KJWW ENGINEERING RESERVES PROPRIETARY RIGHTS, INCLUDING COPYRIGHTS, TO THIS DRAWING AND THE DATA SHOWN THEREON. SAID DRAWING AND/OR DATA ARE THE EXCLUSIVE PROPERTY OF KJWW ENGINEERING AND SHALL NOT BE USED OR REPRODUCED FOR ANY OTHER PROJECT WITHOUT THE EXPRESS WRITTEN APPROVAL AND PARTICIPATION OF KJWW ENGINEERING.


REFERENCE SCALE IN INCHES

EV

SECOND FLOOR PLAN

DRAWN BY | CHECKED BY

03.30.2012

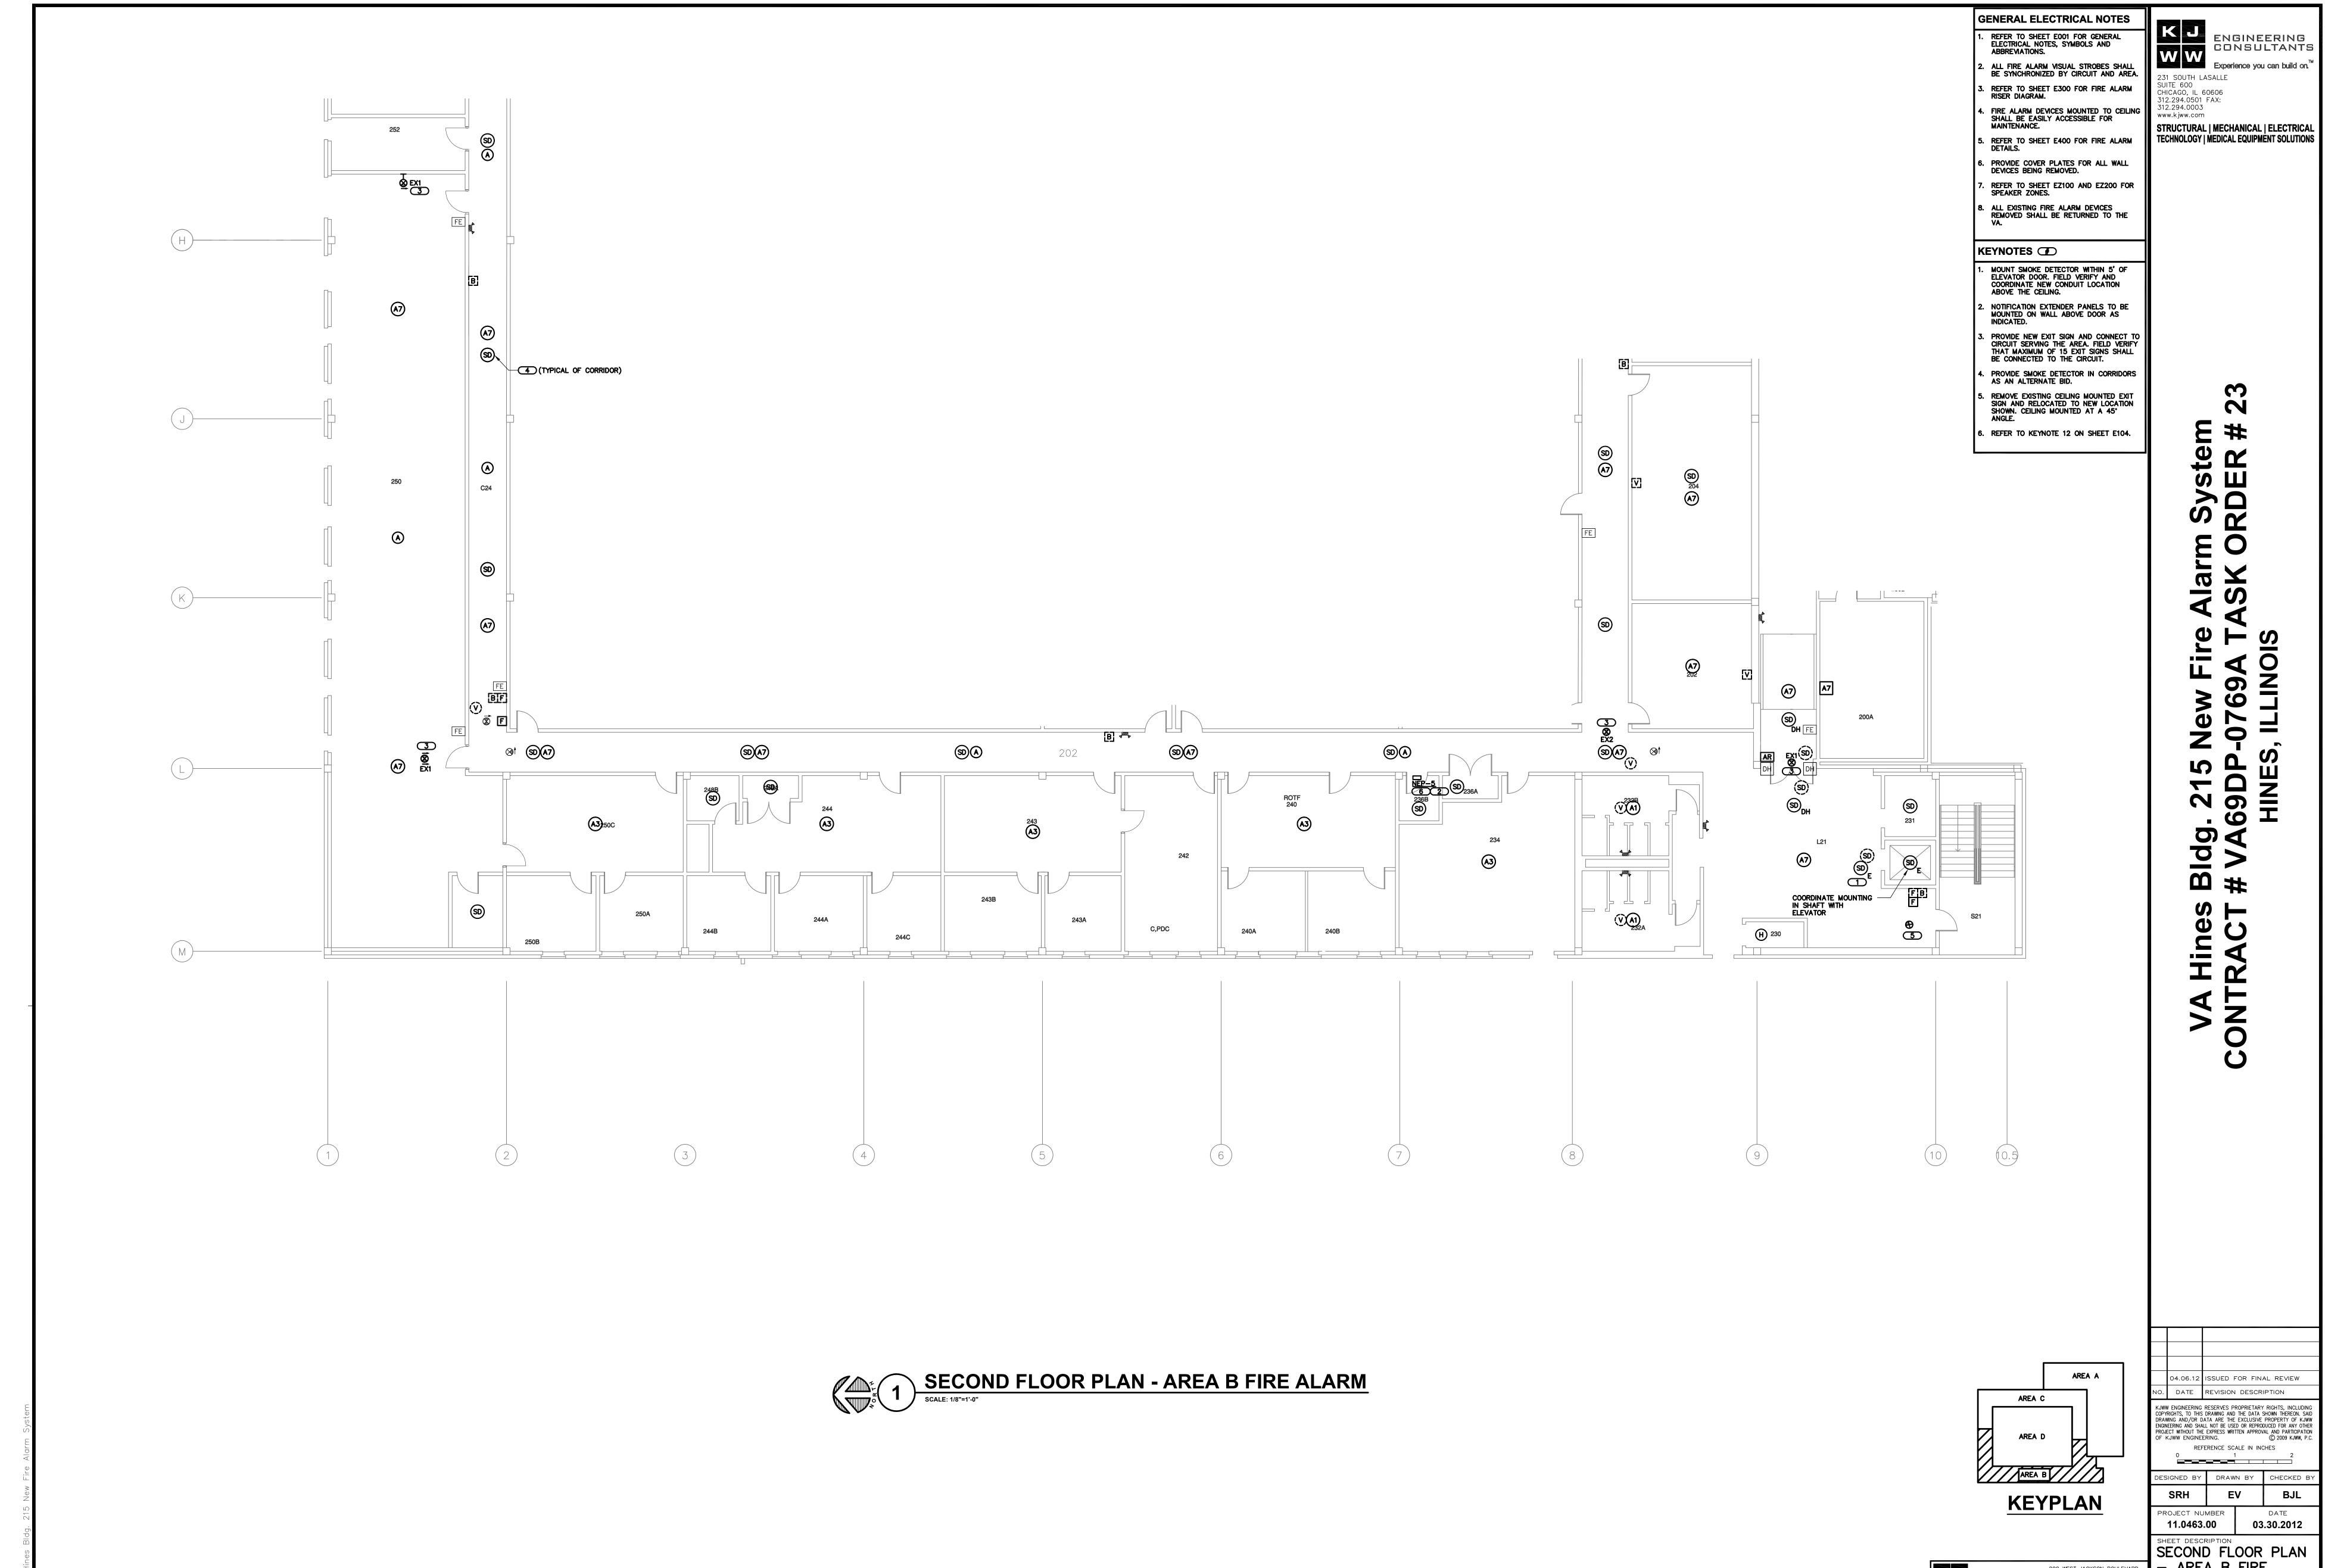


KJWW ENGINEERING RESERVES PROPRIETARY RIGHTS. INCLUDING KOWW ENGINEERING RESERVES PROPRIETARY RIGHTS, INCLUDING COPYRIGHTS, TO THIS DRAWING AND THE DATA SHOWN THEREON. SAID DRAWING AND/OR DATA ARE THE EXCLUSIVE PROPERTY OF KJWW ENGINEERING AND SHALL NOT BE USED OR REPRODUCED FOR ANY OTHER PROJECT WITHOUT THE EXPRESS WRITTEN APPROVAL AND PARTICIPATION OF KJWW ENGINEERING. © 2009 KJWW, P.C. ESIGNED BY DRAWN BY CHECKED BY BJL 03.30.2012 - AREA B FIRE


ENGINEERING
CONSULTANTS

200 WEST JACKSON BOULEVARD
SUITE 1200
CHICAGO, IL 60606
312.294.0501 FAX: 312.294.0003 Experience you can build on. www.kjww.com KJWW ENGINEERING RESERVES PROPRIETARY RIGHTS, INCLUDING COPYRIGHTS, TO THIS DRAWING AND THE DATA SHOWN THEREON. SAID DRAWING AND/OR DATA ARE THE EXCLUSIVE PROPERTY OF KJWW ENGINEERING AND SHALL NOT BE USED OR REPRODUCED FOR ANY OTHER PROJECT WITHOUT THE EXPRESS WRITTEN APPROVAL AND PARTICIPATION OF KJWW ENGINEERING. © 2009 KJWW, P.C. REFERENCE SCALE IN INCHES

ALARM SHEET NUMBER

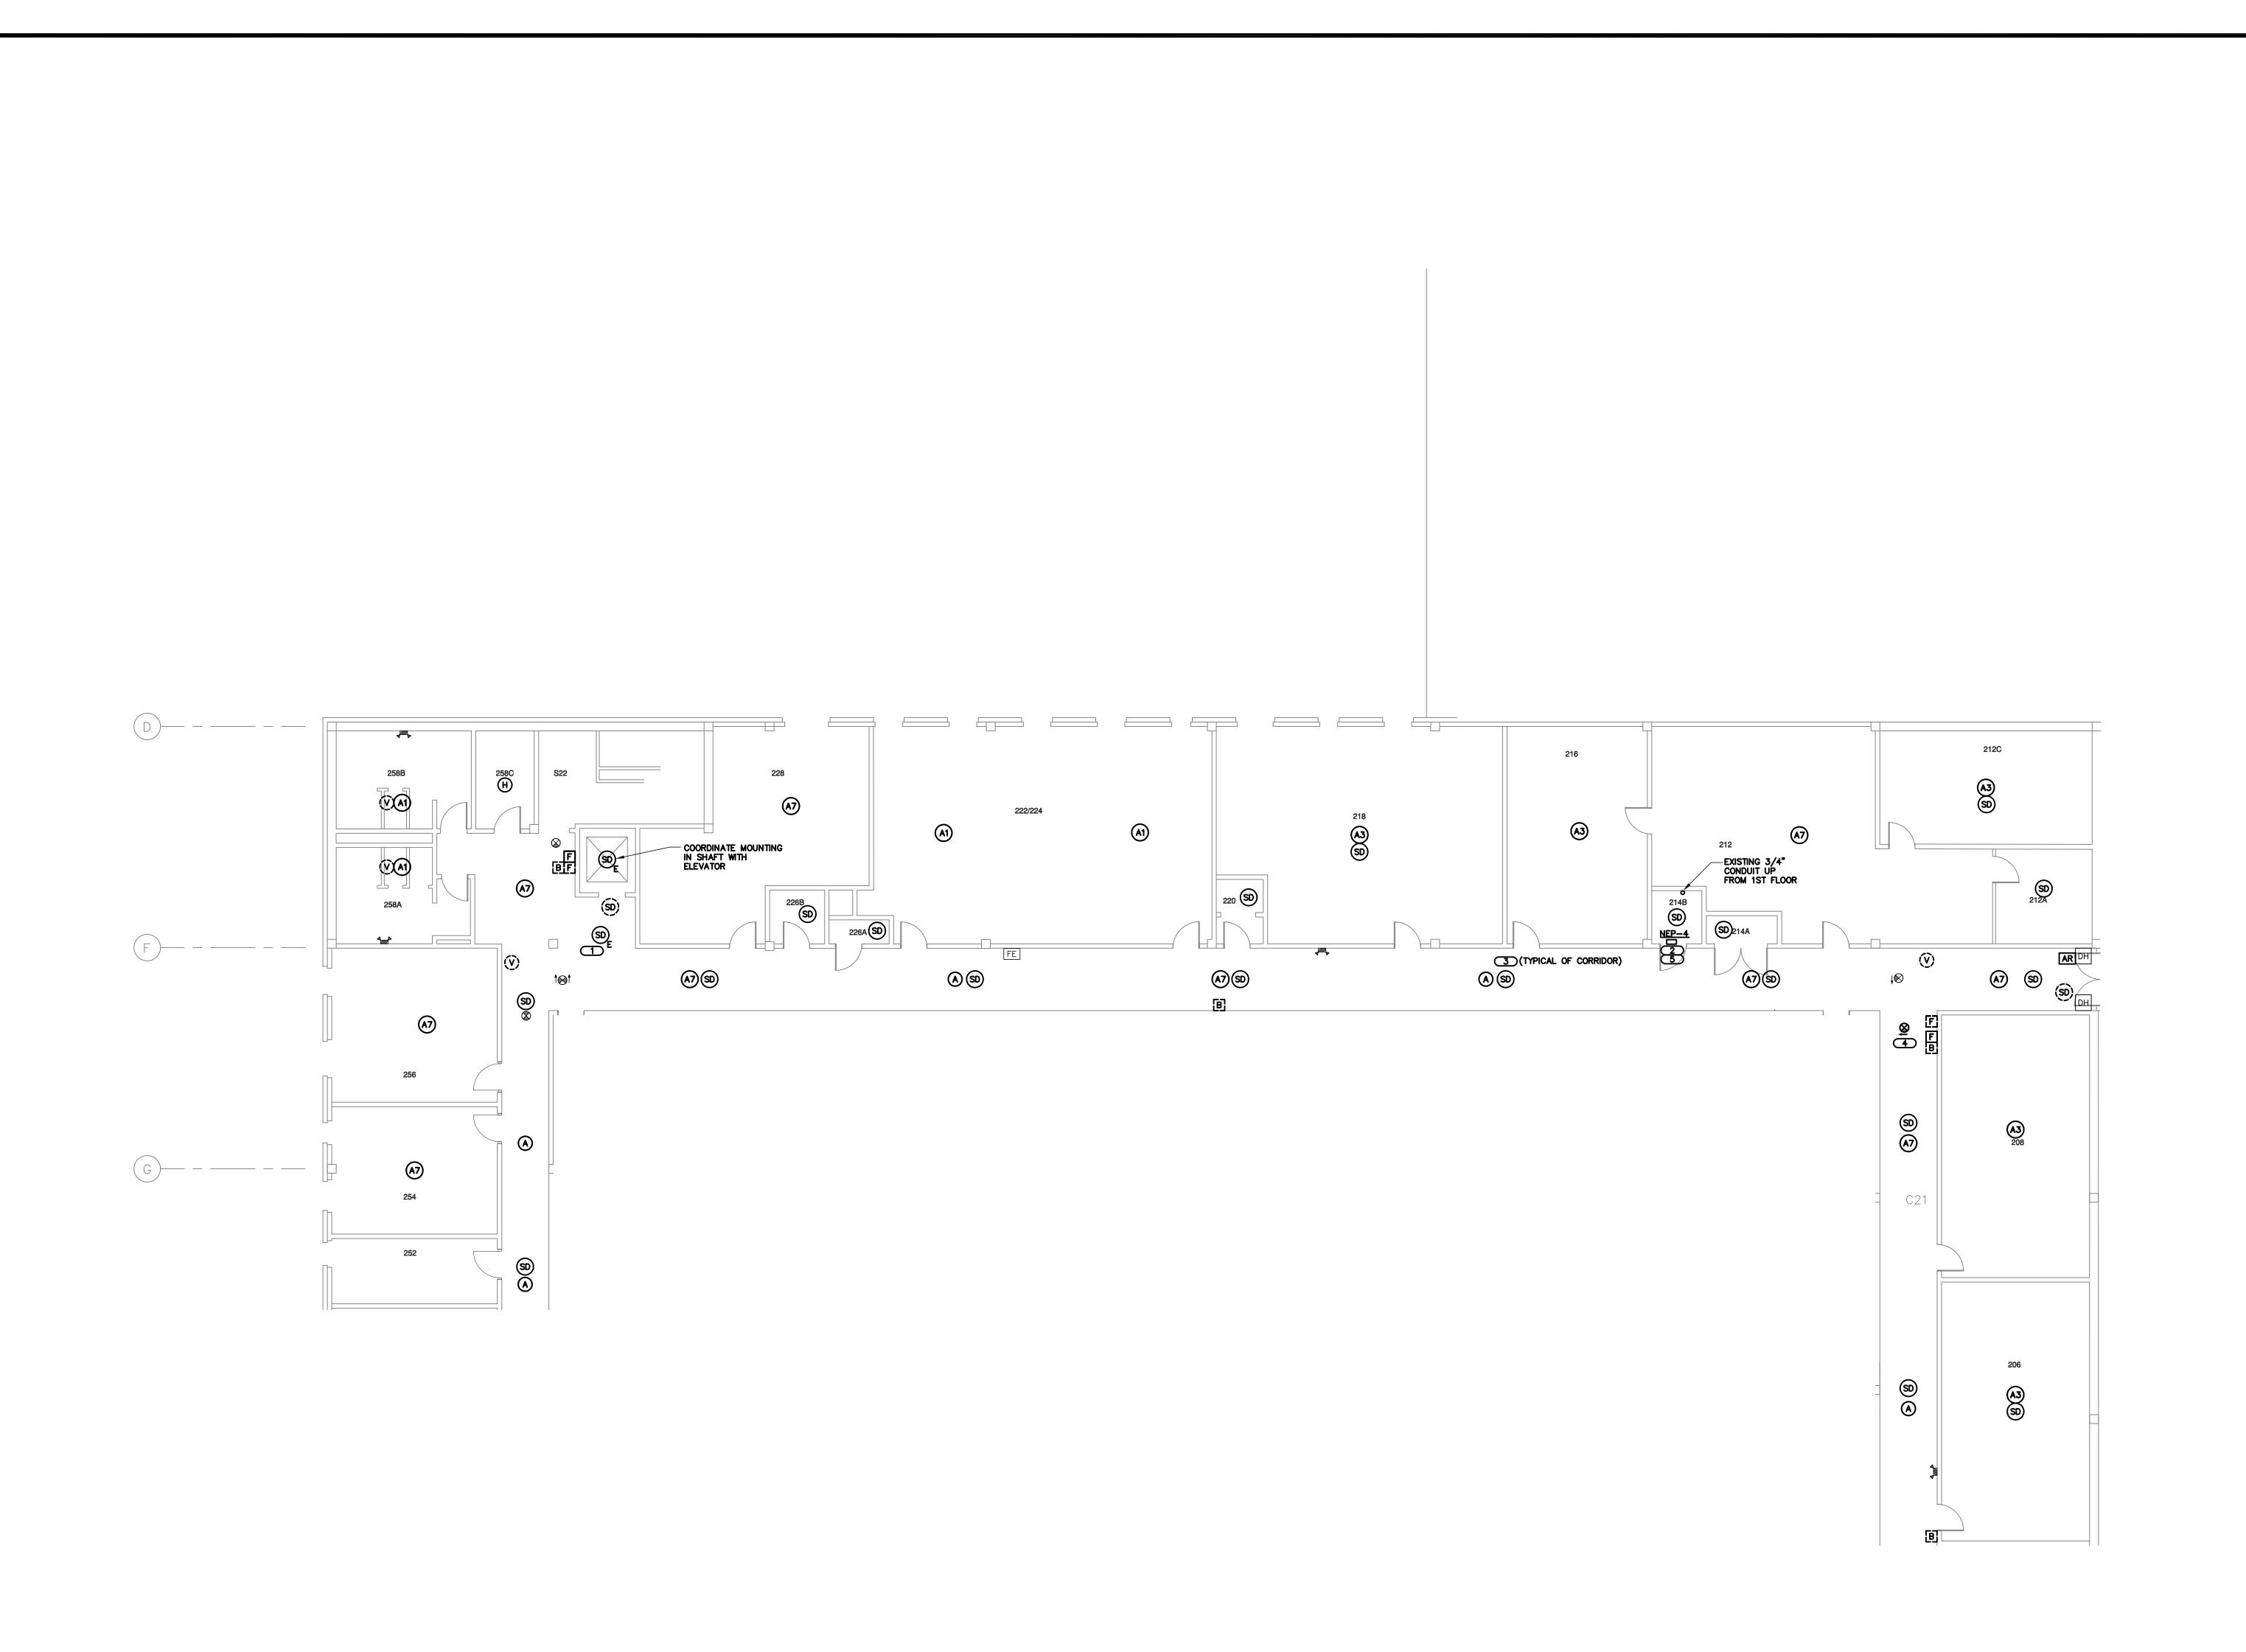

SECOND FLOOR PLAN - AREA C FIRE ALARM

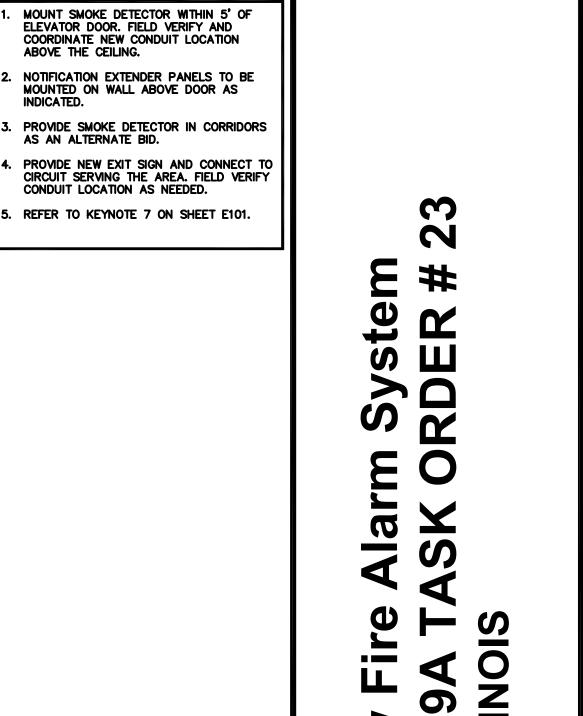

Experience you can build on.

STRUCTURAL | MECHANICAL | ELECTRICAL TECHNOLOGY | MEDICAL EQUIPMENT SOLUTIONS

231 SOUTH LASALLE

SUITE 600 CHICAGO, IL 60606 312.294.0501 FAX: 312.294.0003

www.kjww.com

GENERAL ELECTRICAL NOTES

1. REFER TO SHEET E001 FOR GENERAL ELECTRICAL NOTES, SYMBOLS AND ABBREVIATIONS.

2. ALL FIRE ALARM VISUAL STROBES SHALL BE SYNCHRONIZED BY CIRCUIT AND AREA.

3. REFER TO SHEET E300 FOR FIRE ALARM RISER DIAGRAM.

4. FIRE ALARM DEVICES MOUNTED TO CEILING SHALL BE EASILY ACCESSIBLE FOR MAINTENANCE.

5. REFER TO SHEET E400 FOR FIRE ALARM DETAILS.

6. PROVIDE COVER PLATES FOR ALL WALL DEVICES BEING REMOVED.

7. REFER TO SHEET EZ100 AND EZ200 FOR SPEAKER ZONES.

3. ALL EXISTING FIRE ALARM DEVICES REMOVED SHALL BE RETURNED TO THE VA.

KEYNOTES (F)

AREA C KJWW ENGINEERING RESERVES PROPRIETARY RIGHTS. INCLUDING COPYRIGHTS, TO THIS DRAWING AND THE DATA SHOWN THEREON. SAID DRAWING AND/OR DATA ARE THE EXCLUSIVE PROPERTY OF KJWW ENGINEERING AND SHALL NOT BE USED OR REPRODUCED FOR ANY OTHER PROJECT WITHOUT THE EXPRESS WRITTEN APPROVAL AND PARTICIPATION OF KJWW ENGINEERING. REFERENCE SCALE IN INCHES SIGNED BY DRAWN BY CHECKED BY SRH ΕV BJL **KEYPLAN** PROJECT NUMBER 03.30.2012 11.0463.00

SHEET DESCRIPTION


SECOND FLOOR PLAN - AREA C FIRE ALARM ENGINEERING SUITE 1200 CHICAGO, IL 60606 312.294.0501 FAX: 312.294.0003 Experience you can build on." www.kjww.com KJWW ENGINEERING RESERVES PROPRIETARY, INCLUDING COPYRIGHTS, TO THIS DRAWING AND THE DATA SHOWN THEREON. SAID DRAWING AND/OR DATA ARE THE EXCLUSIVE PROPERTY OF KJWW ENGINEERING AND SHALL NOT BE USED OR REPRODUCED FOR ANY OTHER PROJECT WITHOUT THE EXPRESS WRITTEN APPROVAL AND PARTICIPATION OF KJWW ENGINEERING. © 2009 KJWW, P.C.

AREA B

REFERENCE SCALE IN INCHES


U 1 2

SHEET NUMBER

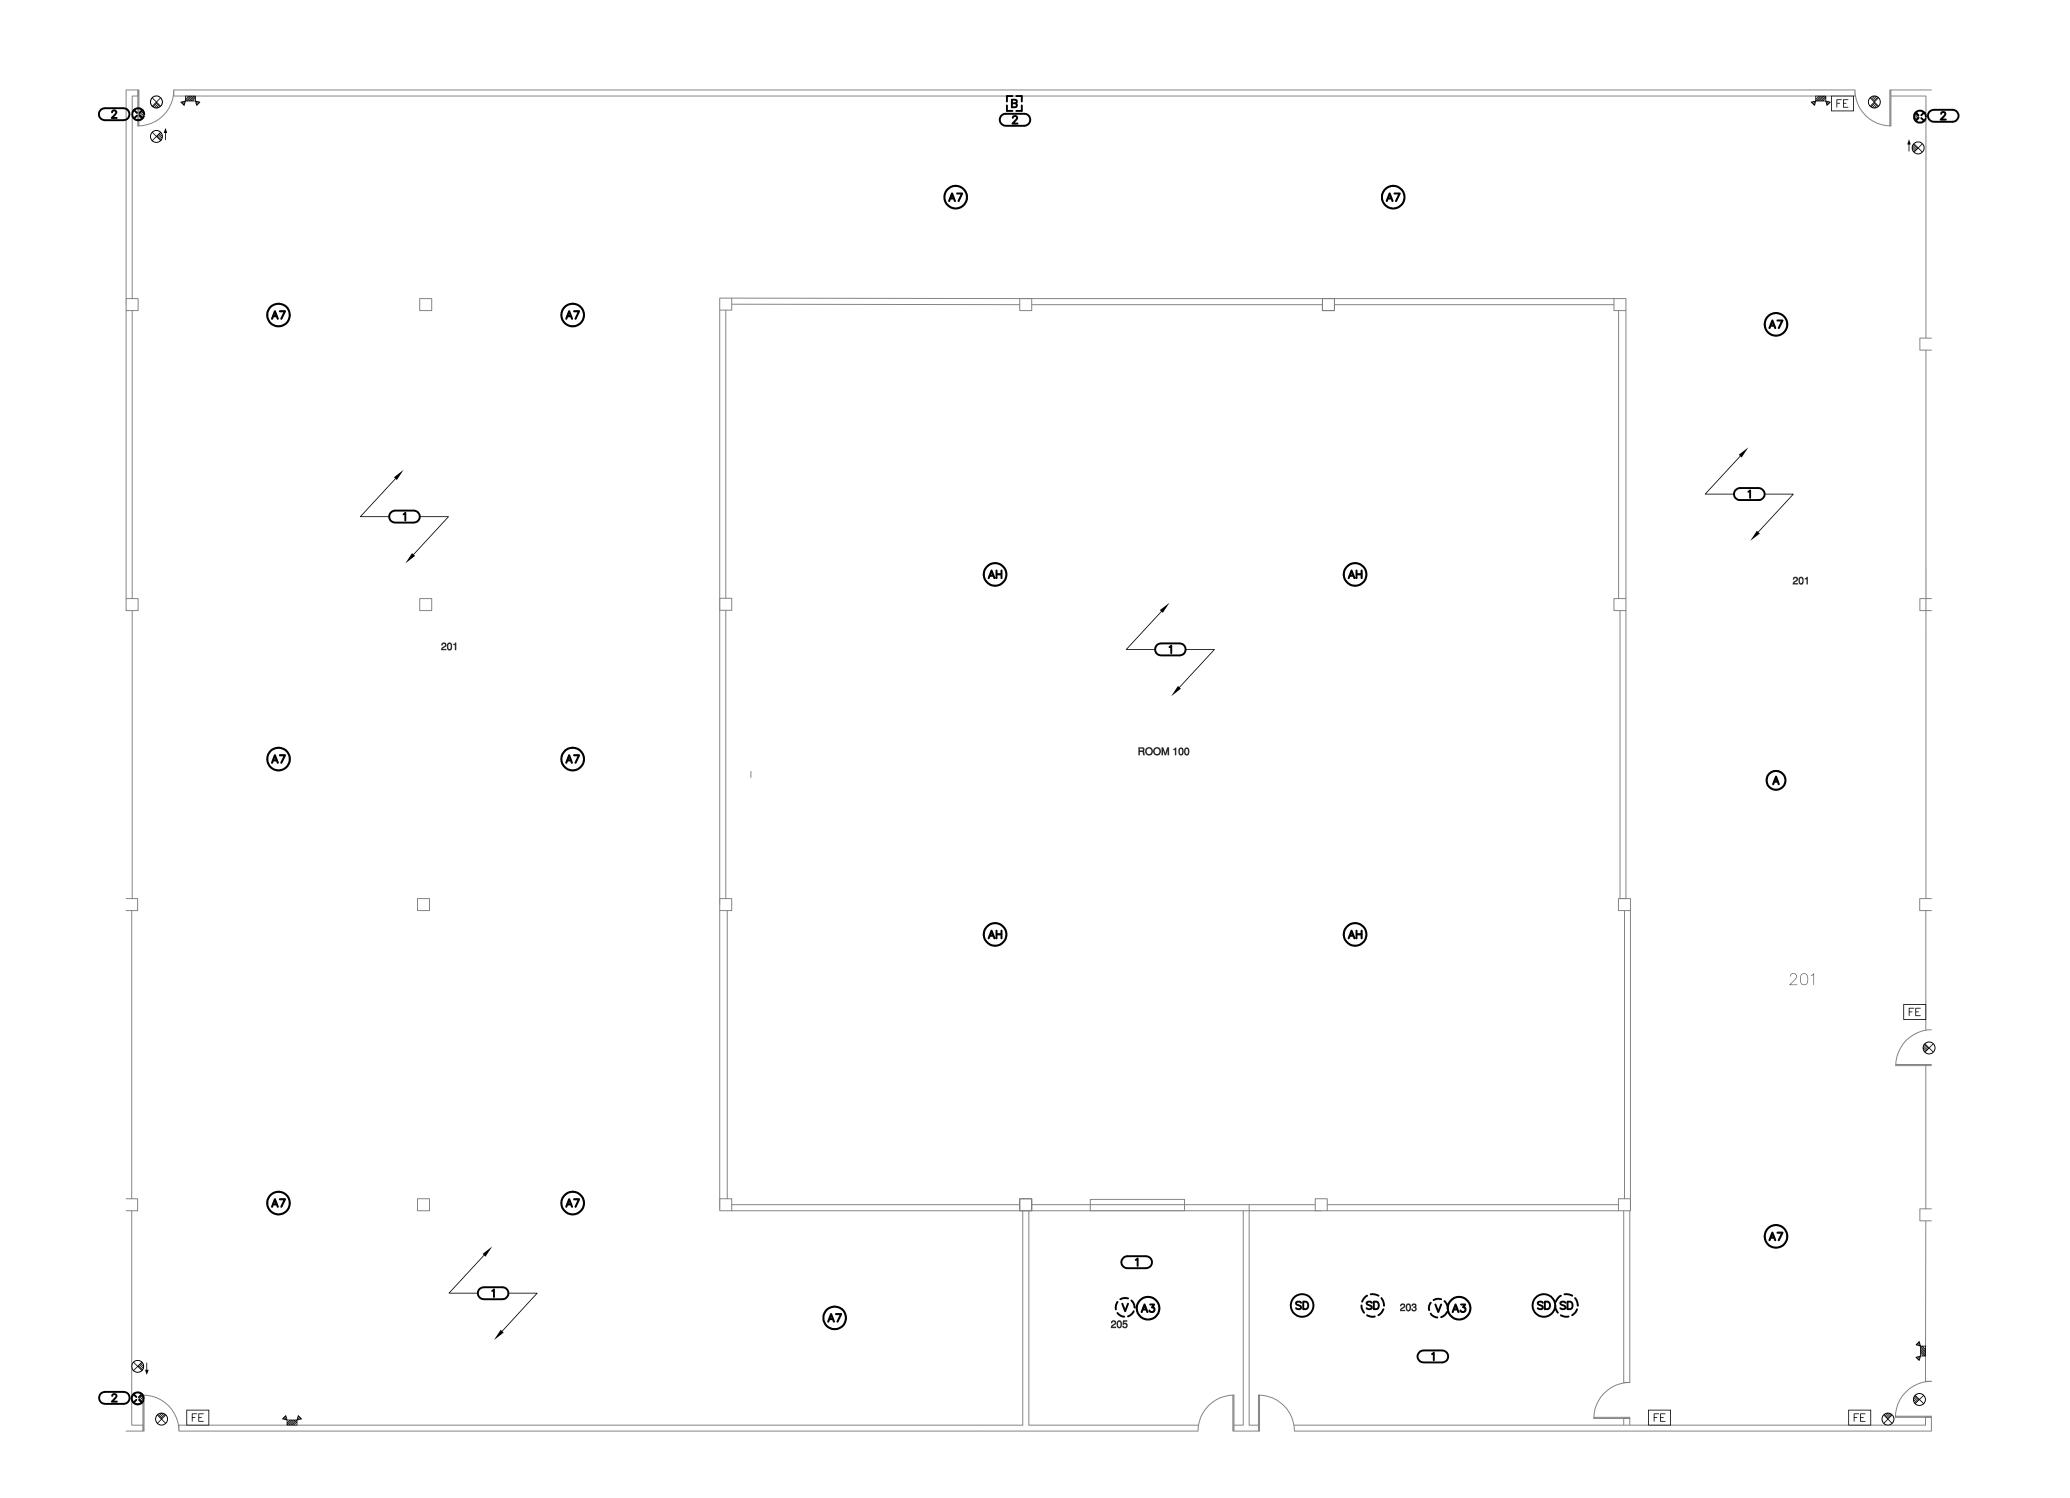

SECOND FLOOR PLAN - AREA D FIRE ALARM

SCALE: 1/8"=1'-0"

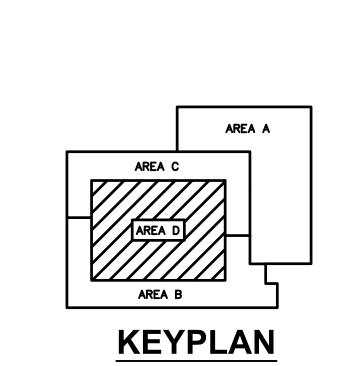

200 WEST JACKSON BOULEVARD SUITE 1200
ENGINERING
CONSULTANTS
EXPERIENCE YOU CEN build an. WWW.kjww.com
PROJECT # 11.0463.00

KJWW ENGINEERING RESERVES PROPRIETARY RIGHTS, INCLUDING COPYRIGHTS, TO THIS DRAWING AND THE DATA SHOWN THEREON. SAID DRAWING AND/OR DATA ARE THE EXCLUSIVE PROPERTY OF KJWW ENGINEERING AND SHALL NOT BE USED OR REPRODUCED FOR ANY OTHER PROJECT WITHOUT THE EXPRESS WRITTEN APPROVAL AND PARTICIPATION OF KJWW ENGINEERING. © 2009 KJWW, P.C. REFERENCE SCALE IN INCHES

SECOND FLOOR PLAN

- AREA D FIRE ALARM 0 1 2

Experience you can build on.

GENERAL ELECTRICAL NOTES

I. REFER TO SHEET EOO1 FOR GENERAL ELECTRICAL NOTES, SYMBOLS AND ABBREVIATIONS.

KEYNOTES (#)

I. PROVIDE NEW DEVICES AS SHOWN AND CONNECT TO NEW SIMPLEX FIRE ALARM PANEL FAP-1.

2. TO BE REMOVED (DEMO) BLANK OPENING.

2. ALL FIRE ALARM VISUAL STROBES SHALL BE SYNCHRONIZED BY CIRCUIT AND AREA. 231 SOUTH LASALLE SUITE 600 CHICAGO, IL 60606 312.294.0501 FAX: 312.294.0003 3. REFER TO SHEET E300 FOR FIRE ALARM RISER DIAGRAM. 4. FIRE ALARM DEVICES MOUNTED TO CEILING SHALL BE EASILY ACCESSIBLE FOR MAINTENANCE. www.kjww.com STRUCTURAL | MECHANICAL | ELECTRICAL TECHNOLOGY | MEDICAL EQUIPMENT SOLUTIONS REFER TO SHEET E400 FOR FIRE ALARM DETAILS. 6. PROVIDE COVER PLATES FOR ALL WALL DEVICES BEING REMOVED. REFER TO SHEET EZ100 AND EZ200 FOR SPEAKER ZONES. 3. ALL EXISTING FIRE ALARM DEVICES REMOVED SHALL BE RETURNED TO THE VA.

9A 0N

KJWW ENGINEERING RESERVES PROPRIETARY RIGHTS, INCLUDING COPYRIGHTS, TO THIS DRAWING AND THE DATA SHOWN THEREON. SAID DRAWING AND/OR DATA ARE THE EXCLUSIVE PROPERTY OF KJWW ENGINEERING AND SHALL NOT BE USED OR REPRODUCED FOR ANY OTHER PROJECT WITHOUT THE EXPRESS WRITTEN APPROVAL AND PARTICIPATION OF KJWW ENGINEERING.

REFERENCE SCALE IN INCHES

EV

SHEET NUMBER

DRAWN BY | CHECKED BY


BJL

03.30.2012

ESIGNED BY

PROJECT NUMBER 11.0463.00

SRH

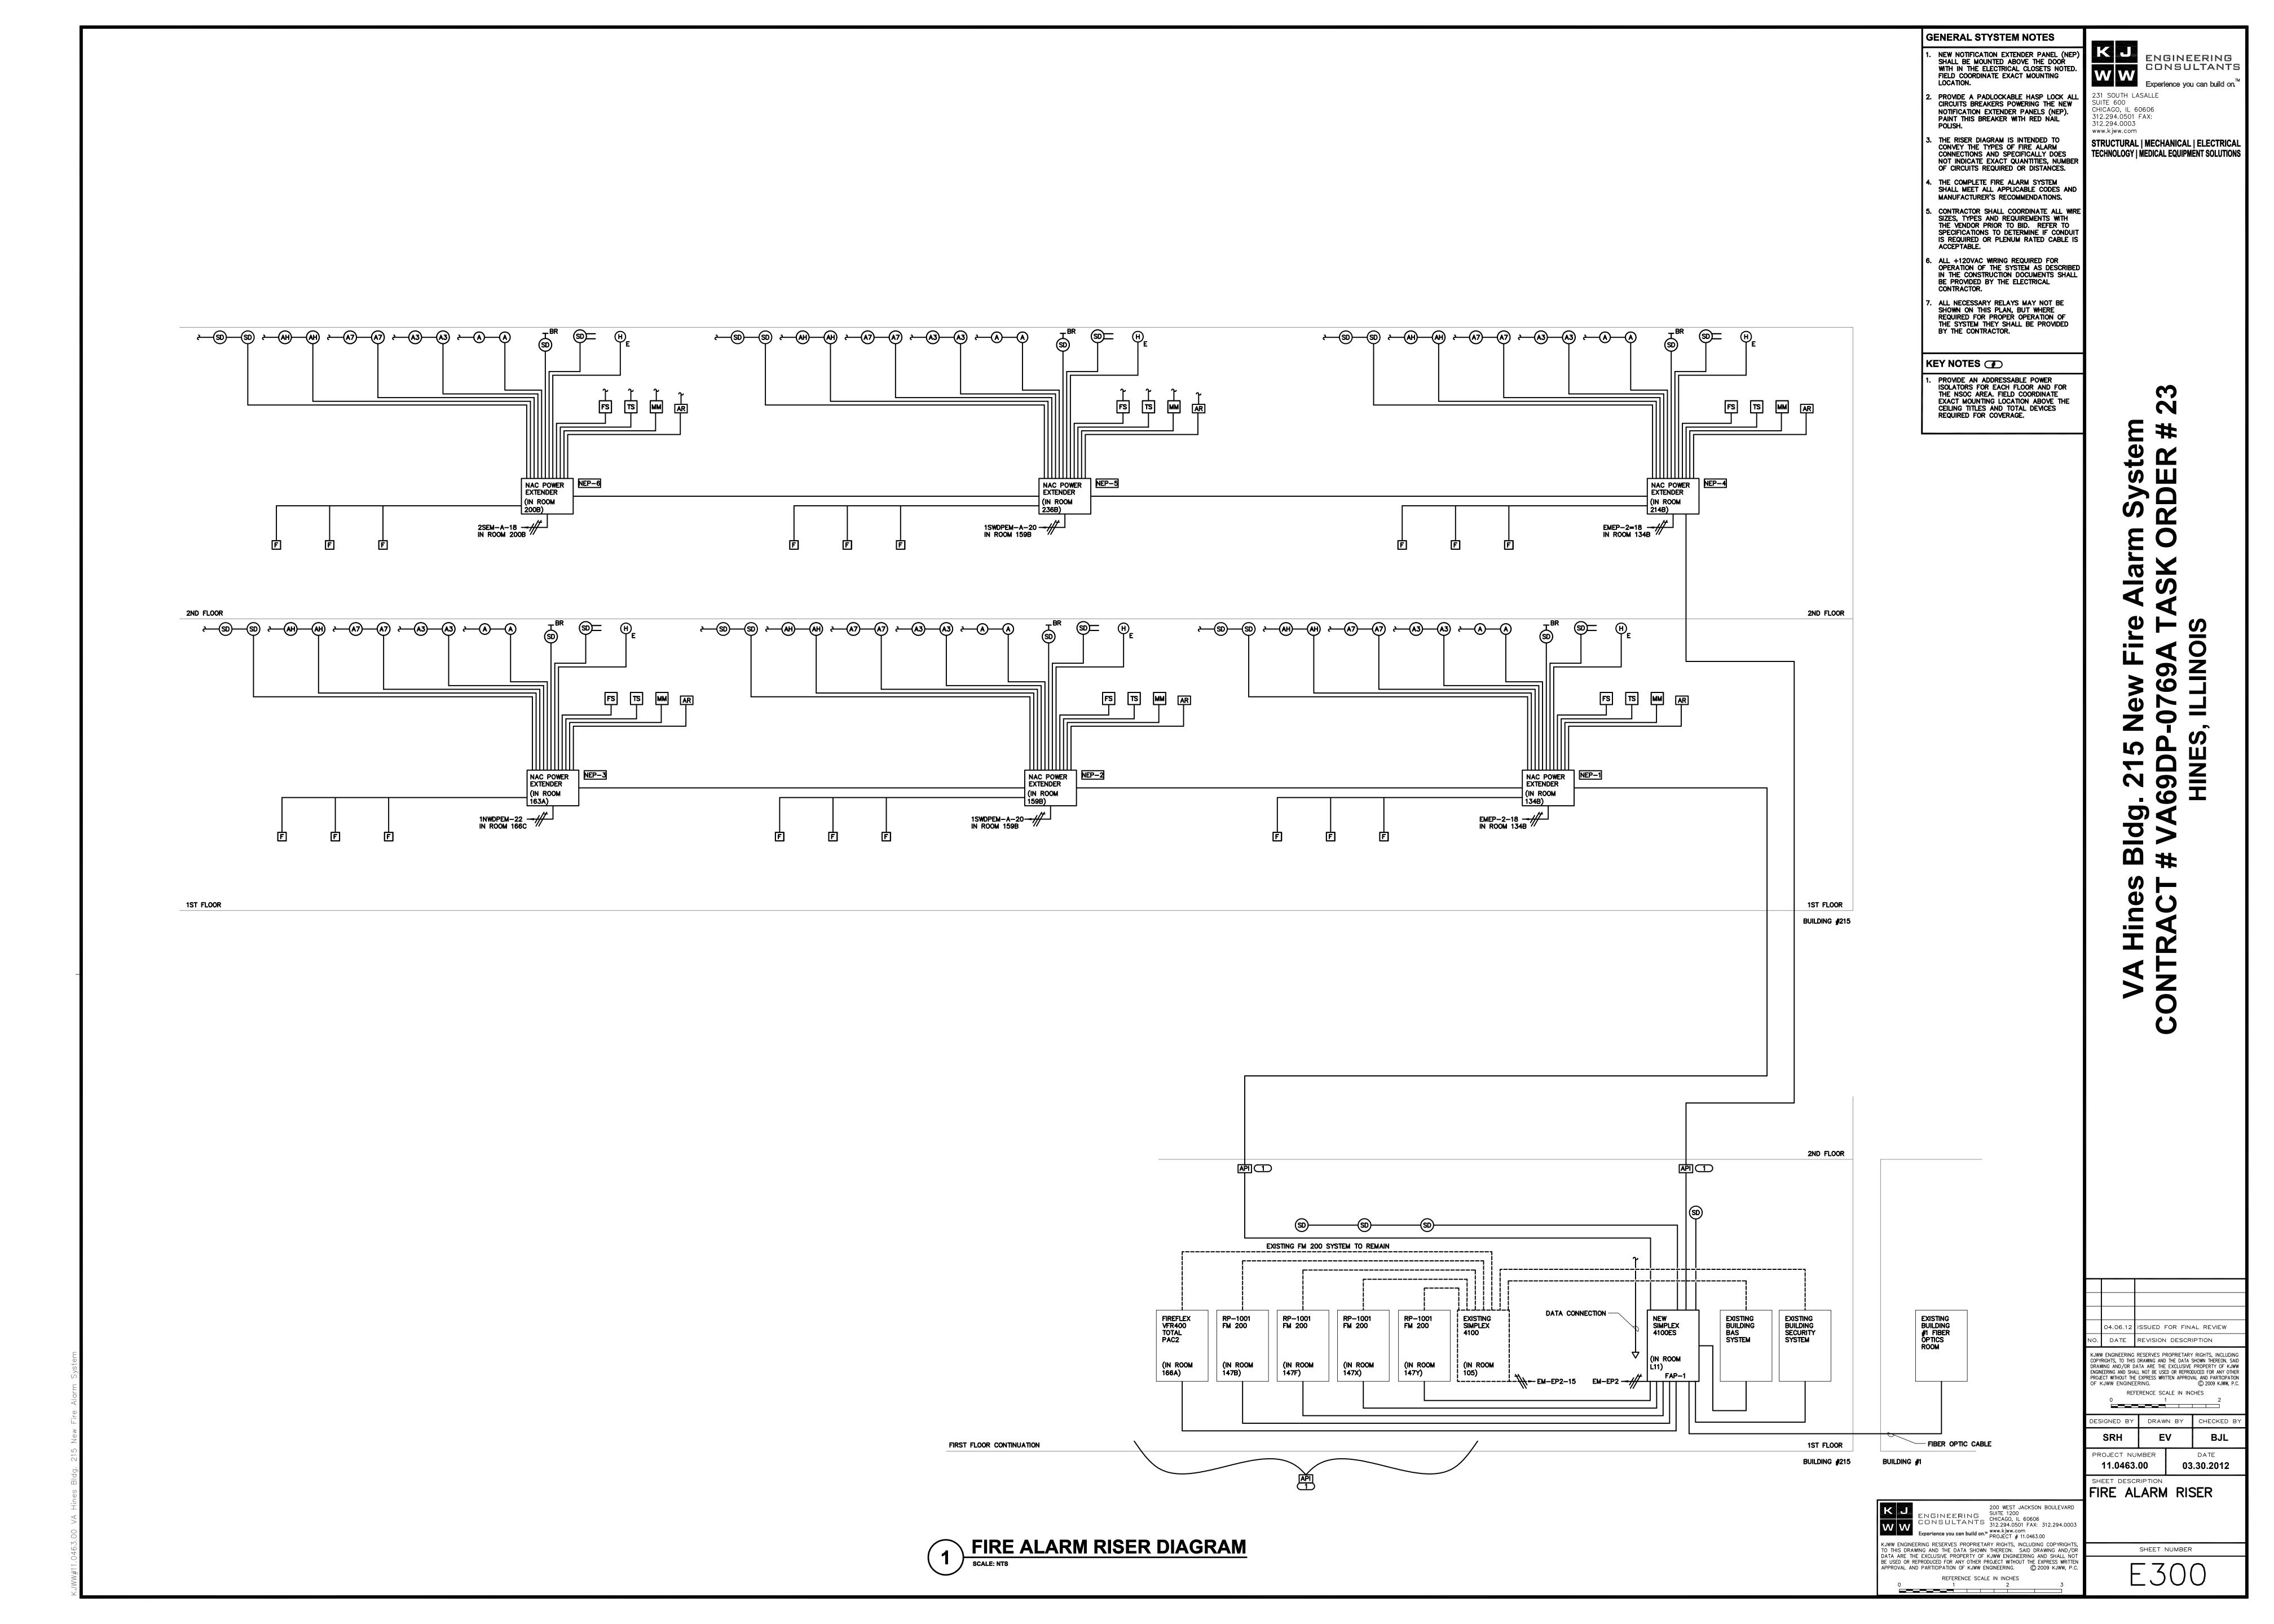

ELECTRICAL MATERIAL LIST

THE SYMBOLS AND THE MATERIAL LIST ARE FOR THE CONVENIENCE OF THE CONTRACTOR. EACH CONTRACTOR SHALL BE RESPONSIBLE FOR VERIFICATION OF QUANTITIES AND SHALL FURNISH ALL MATERIAL REQUIRED, WHETHER SPECIFIED OR NOT, TO PRODUCE A SATISFACTORY WORKING SYSTEM. CATALOG NUMBERS SHALL NOT BE CONSIDERED COMPLETE BUT ARE GIVEN ONLY TO AID THE CONTRACTOR IN THE SEARCH FOR MATERIAL. NO MATERIAL SHALL BE ORDERED BY MANUFACTURER AND CATALOG NUMBER ONLY. EACH CONTRACTOR SHALL FIRST READ THE COMPLETE DESCRIPTION OF THE MATERIAL ON THESE DRAWINGS AND SPECIFICATIONS. THE FIRST MANUFACTURER LISTED IS THE BASIS OF DESIGN. "STANDARD COLOR" INDICATES FACTORY FINISH AVAILABLE AT NO ADDITIONAL CHARGE.


NO.	SYMBOL	DESCRIPTION	APPROVED MANUFACTUR
1	COVER PLATES	ALL SWITCHES, RECEPTACLES, AND OUTLETS SHALL BE COMPLETE WITH VA STANDARD COVERPLATES IN FINISHED SPACES WHERE WALLS ARE FINISHED; #302 STAINLESS STEEL COVERPLATES IN UNFINISHED SPACES FOR FLUSH BOXES; AND GALVANIZED STEEL COVERPLATES IN UNFINISHED SPACES FOR SURFACE MOUNTED BOXES. WHERE SEVERAL DEVICES ARE GANGED TOGETHER, THE COVER PLATE SHALL BE OF THE GANGED STYLE FOR THE NUMBER OF DEVICES USED. INSTALL NAMEPLATE IDENTIFICATION WHERE INDICATED PER VA REQUIREMENTS.	HUBBELL LEVITON PASS & SEYMOUR COOPER
2	▽	TECHNOLOGY ROUGH-IN, FLUSH MOUNT ON WALL OR AS NOTED IN PLANS. ALL TECHNOLOGY ROUGH-INS SHALL HAVE ONE (1) DOUBLE GANG BOX WITH SINGLE GANG PLASTER RING, APPROPRIATE COVERPLATE, AND ONE (1) 1" CONDUIT STUBBED TO ABOVE THE LAY-IN CEILING.	
3	V1 V3 V7 VH	FIRE ALARM VISUAL NOTIFICATION APPLIANCE, HIGH—INTENSITY STROBE, RED HOUSING WITH WHITE "ALERT" LETTERING OR PICTOGRAM, SEMI—FLUSH WALL MOUNT; 24 VDC. CANDELA RATINGS: V1=15, V3=30, V7=75, AND VH=110. CANDELA RATING SHALL BE VISIBLE FROM THE OUTSIDE OF THE DEVICE.	SIMPLEX 4904
4	(N) (V3) (V7) (W1)	FIRE ALARM CEILING VISUAL NOTIFICATION APPLIANCE, HIGH—INTENSITY STROBE, WHITE HOUSING WITH RED "ALERT" LETTERING OR PICTOGRAM, SEMI—FLUSH CEILING MOUNT; 24 VDC. CANDELA RATINGS: V1=15, V3=30, V7=75, V9=95, VH=115, VS=177. CANDELA RATING SHALL BE VISIBLE FROM THE OUTSIDE OF THE DEVICE.	SIMPLEX
5	A1 A3 AH	FIRE ALARM VOICE/VISUAL NOTIFICATION APPLIANCE, SPEAKER WITH HIGH-INTENSITY STROBE, SEMI-FLUSH WALL MOUNT, RED HOUSING WITH WHITE "ALERT" LETTERING OR PICTOGRAM, 25 VRMS, MINIMUM OF 4 TAP SETTINGS WHICH SHALL ALLOW FIELD ADJUSTMENT OF THE SOUND OUTPUT ACROSS A MINIMUM RANGE OF 78-87 DBA (UL 1480), 400Hz-4KHZ (6dBA CUTOFF) FREQUENCY RANGE. CANDELA RATINGS: A1=15, A3=30, A7=75, AND AH=110. CANDELA RATING SHALL BE VISIBLE FROM THE OUTSIDE OF THE DEVICE.	SIMPLEX
6	(A) (A3) (A7) (AH)	FIRE ALARM VOICE/VISUAL NOTIFICATION APPLIANCE, 4" SPEAKER, ROUND HOUSING, FLUSH CEILING MOUNT (PROVIDE TILE BRIDGE WHERE APPLICABLE), WHITE WITH RED "ALERT" LETTERING OR PICTOGRAM, 25 VRMS, MINIMUM OF 4 TAP SETTINGS WHICH SHALL ALLOW FIELD ADJUSTMENT OF THE SOUND OUTPUT ACROSS A MINIMUM RANGE OF 78-87 DBA (UL 1480), 400Hz-4KHZ (6dBA CUTOFF) FREQUENCY RANGE. CANDELA RATINGS: A1=15, A3=30, A7=75, A9=95, AH=115, AS=177.	SIMPLEX
7	AW	WEATHERPROOF FIRE ALARM AUDIO/VISUAL NOTIFICATION APPLIANCE, ELECTRONIC HORN WITH HIGH-INTENSITY STROBE, SQUARE HOUSING, SEMI-FLUSH WALL MOUNT, RED WITH WHITE "ALERT" LETTERING, 75 CANDELA RATING, 24 VDC FOR WET LOCATIONS, PROVIDE WITH WEATHERPROOF BACK BOX. CONDUIT SHALL NOT BE EXPOSED.	SIMPLEX
8	A	FIRE ALARM VOICE NOTIFICATION APPLIANCE, 4" SPEAKER, ROUND HOUSING, FLUSH CEILING MOUNT (PROVIDE TILE BRIDGE WHERE APPLICABLE), WHITE WITH NO LETTERING, 25 VRMS, MINIMUM OF 4 TAP SETTINGS WHICH SHALL ALLOW FIELD ADJUSTMENT OF THE SOUND OUTPUT ACROSS A MINIMUM RANGE OF 78-87 DBA (UL 1480), 400Hz-4KHZ (6dBA CUTOFF) FREQUENCY RANGE.	SIMPLEX
9	∐ §®	DUCT-TYPE SMOKE DETECTOR, ADDRESSABLE, ANALOG PHOTOELECTRIC SENSOR, , 24 VDC, MULTI-FUNCTION LED INDICATOR, SAMPLING TUBES SIZED TO MATCH DUCT APPLICATION, HOUSING WITH COMPLETE MOUNTING ACCESSORIES. PROVIDE A REMOTE ALARM LED INDICATOR DEVICE IF DETECTOR IS NOT VISIBLE FROM A FLOOR-STANDING POSITION. IF DETECTOR IS LOCATED ABOVE A SUSPENDED CEILING, MOUNT REMOTE INDICATOR IN CEILING DIRECTLY BELOW DETECTOR WITH A WHITE SINGLE-GANG FACEPLATE LABELED: DUCT SMOKE DETECTOR.	SIMPLEX 4098 SERIES W/ 2098-9808
10	Œ	HEAT DETECTOR, ADDRESSABLE, ANALOG SENSOR, COMBINATION RATE OF RISE AND 135 DEGREE FAHRENHEIT FIXED TEMPERATURE, 2—WIRE OPERATION, 24 VDC, 2—PIECE DESIGN, LOW—PROFILE MOUNTING BASE WITH MULTI—FUNCTION LED INDICATOR, COMPLETE WITH MOUNTING HARDWARE AND BACKBOX. PROVIDE A REMOTE LED INDICATOR DEVICE IF DETECTOR IS NOT VISIBLE FROM A FLOOR—STANDING POSITION. A SUBSCRIPT IS USED TO IDENTIFY THE DEVICE WITH A SPECIFIC SEQUENCE OF OPERATION AS FOLLOWS: E = ELEVATOR SHUTDOWN.	SIMPLEX 4098 SERIES
11	SD TBT SD BT	PROJECTED BEAM TYPE SMOKE DETECTOR TRANSMITTER AND RECEIVER, MICROPROCESSOR BASED DESIGN, ACCESS COVERS MONITORED BY INTEGRAL TAMPER SWITCH, ALARM AND TROUBLE AUXILIARY OUTPUT CONTACTS, BEIGE HOUSING WITH BLACK FACE, MATCHING REMOTE INDICATOR/TEST PANEL, 24 VDC. PROVIDE WITH TWO (2) ADDRESSABLE MONITOR MODULES FOR MONITORING ALARM AND TROUBLE OUTPUT CONTACTS.	SIMPLEX 4098 SERIES
12	F	FIRE ALARM MANUAL PULL STATION, ADDRESSABLE, SINGLE ACTION, RESET KEY LOCK, SEMI—FLUSH MOUNT, RED HIGH—ABUSE PLASTIC OR CAST METAL CONSTRUCTION WITH WHITE LETTERING. USE SURFACE MOUNT ONLY ON PRECAST CONCRETE OR STRUCTURE.	SIMPLEX 2099 SERIES
13	AR	FIRE ALARM ADDRESSABLE RELAY CONSISTING OF AN ADDRESSABLE CONTROL MODULE AND SLAVE RELAY WITH CONTACTS SUITABLE FOR CONTROLLING THE DESIGNATED AUXILIARY LOAD, 24 VDC, 4—WRE OPERATION, SURFACE MOUNT ENCLOSURE. PROVIDE A SURFACE ENCLOSURE WHERE LOCATED ABOVE CEILING OR IN UNFINISHED SPACE. PROVIDE A FLUSH ENCLOSURE IN FINISHED SPACE.	SIMPLEX 2190 SERIES 2088 SERIES
14	ММ	FIRE ALARM ADDRESSABLE MONITOR MODULE FOR CONVENTIONAL CLASS B CIRCUITS, 24 VDC, 4—WIRE OPERATION, INTEGRAL END—OF—LINE RESISTOR/RELAY, PROVIDE A SURFACE ENCLOSURE WHERE LOCATED ABOVE CEILING OR IN UNFINISHED SPACE. PROVIDE A FLUSH ENCLOSURE IN FINISHED SPACE.	SIMPLEX 2190 SERIES
15	FS	CONNECTION TO FLOW SWITCH TO MONITOR FIRE PROTECTION FLOW SWITCH OR DISCHARGE OUTPUT CONTACTS. NORMALLY-OPEN DRY CONTACTS FOR FIRE ALARM INTERFACE, FURNISHED AND INSTALLED BY M.C., WIRED BY E.C.	EXISTING TO REMAIN
16	TS	CONNECTION TO MONITOR SWITCH TO MONITOR FIRE PROTECTION SYSTEM SUPERVISORY SWITCHES OR OUTPUT CONTACTS. NORMALLY-OPEN DRY CONTACTS FOR FIRE ALARM INTERFACE, FURNISHED AND INSTALLED BY M.C., WRED BY E.C.	EXISTING TO REMAIN
17	₹	FIRE FIGHTERS MICROPHONE FOR COMMUNICATIONS IN VOICE COMMAND CENTER.	SIMPLEX
18	(SD)	SMOKE DETECTOR, PHOTOELECTRIC TYPE, 2-WIRE OPERATION, 24 VDC, 2-PIECE DESIGN, LOW-PROFILE MOUNTING BASE WITH LED ALARM INDICATOR, COMPLETE WITH MOUNTING HARDWARE AND BACKBOX. PROVIDE A REMOTE LED INDICATOR DEVICE IF DETECTOR IS NOT VISIBLE FROM A FLOOR-STANDING POSITION. A SUBSCRIPT IS USED TO IDENTIFY THE DEVICE WITH A SPECIFIC SEQUENCE OF OPERATION AS FOLLOWS: E = ELEVATOR RECALL, SD = SMOKE DAMPERS, DH = DOOR HOLD RELEASE, ALL DETECTORS IDENTIFIED WITH A SUBSCRIPT SHALL BE	SIMPLEX 2098 SERIES
19	₹	FURNISHED WITH AN AUXILIARY CONTACT. FIRE ALARM AUXILIARY CONTROL RELAY WITH CONTACTS SUITABLE FOR CONTROLLING THE DESIGNATED AUXILIARY LOAD, 24 VDC, 2—WIRE OPERATION, SURFACE MOUNT ENCLOSURE.	SIMPLEX 2088 SERIES
20	RTS	DUCT DETECTOR REMOTE TEST STATION, WITH RED LED STATUS INDICATOR AND REMOTE TEST KEY SWITCH ON A SINGLE GANG STAINLESS STEEL PLATE.	SIMPLEX 2098-9806
21	FAP-1	FIRE ALARM CONTROL PANEL, ADDRESSABLE SYSTEM, SEMI-FLUSH, WITH MICROPHONE, AMPLIFIERS, PROGRAMMABLE KEYPAD, LCD DISPLAY, PAC, DIGITIZED VOICE MESSAGES, EXPANDABLE MODULAR DESIGN, MICROPROCESSOR BASED ELECTRONICS, 120 VAC OPERATION. REFER TO SPECIFICATIONS FOR COMPLETE REQUIREMENTS.	SIMPLEX 4100ES SERIES
22	NEP-#	NAC (NOTIFICATION APPLIANCE CIRCUIT) EXTENDER PANEL, INTEGRAL BATTERY BACKUP, 120 VAC OPERATION, SURFACE MOUNT. REFER TO SPECIFICATIONS FOR COMPLETE REQUIREMENTS.	SAME MANUFACTURER A FIRE ALARM CONTROL PANEL
23	API	ADDRESSABLE POWER ISOLATOR, FOR 4100ES/4100U/4010ES IDNET COMMUNICATIONS. PROVIDE SURFACE MOUNTED TRIM PLATE 4090-9802 PROVIDE DOUBLE GANG BOX PER MANUFACTURERS RECOMMENDATIONS.	SIMPLEX 4090-9117
	<u> </u>		

MOUNTING: (MTG)	LAMP TYPE:	LENS/LOUVER: (L/L)
RE - RECESSED	FL - FLUORESCENT	A125" ACRYLIC
SP - SUSPENDED	BY M.C. CF - COMPACT FLUORES	1120 710111 210
CL - CEILING SURFACE	HL - HALOGEN	C - CLEAR ALZAK
WL - WALL	IN - INCANDESCENT	D - PARABOLIC
UC - UNDER CABINET	LED - LIGHT EMITTING DIC	
CV - COVE	HS - HIGH PRESSURE SO	
PL - POLE	MH - METAL HALIDE	H - WALL WASHER
O - OTHER (SEE DESCRIPTION)	SMH - SUPER METAL HALI	
o official personal float	PSMH - PULSE START META	
DOOR:	CMH - CERAMIC METAL HA	North 2.125 Acritic
FA - FLAT ALUMINUM	QRS- QUARTZ RESTRIKE	L - LOW IRIDESCENT SPECULAR ALUM.
FS - FLAT STEEL	XL - EXTENDED LIFE	N - NONE
RA - REGRESSED ALUMINUM	XLP - EXTENDED LIFE & O	
RS - REGRESSED STEEL	7.2. 2.1.2.2 2 2.0	O - OTHER (SEE DESCRIPTION)
	BALLAST: (BLS)	##BF - BALLAST FACTOR
FINISH:	DIM - DIMMING BALLAST	HL - HIGH / LOW LEVEL BALLAST
PAF - PAINT AFTER FABRICATION	EB - ELECTRONIC BALLA	
CSA - FINISH SELECTION BY ARCHITECT	EM - EMERGENCY BATTE	
	DALI - DIGITAL DIMMING BA	

REFER TO SPECIFICATION SECTIONS INTERIOR LIGHTING 16511 FOR ADDITIONAL INFORMATION AND REQUIREMENTS.

ALL FLUORESCENT FIXTURES SHALL BE INTERNALLY FUSED. ALL LAMPS FOR THIS PROJECT SHALL BE FURNISHED AND INSTALLED BY THE ELECTRICAL CONTRACTOR UNLESS OTHERWISE NOTED. FLUORESCENT LAMP CORRELATED COLOR TEMPERATURE 3500° COLOR RENDERING INDEX (CRI) AT OR ABOVE 80, UNLESS NOTED OTHERWISE.

•	OTHERWISE.										
					LAMPS						
ITEM	DESCRIPTION	SIZE	MTG	TYPE	QUANTITY & SIZE	VOLTS / BLS	L/L	APPROVED MANUFACTURER			
EX1 EX2	STEEL BOX LED EXIT SIGN WITH RED LETTERS ON WHITE BACKGROUND, WITH BATTERY BACK-UP. SINGLE AND DOUBLE FACE.	12 1/4" W 4 1/2"x 9"H	CL	LED	5 WATT L.E.D.	120V EB EM MV	P	SURE-LITE CHX600 SERIES ALKO EG-LED SERIES EXITRONIX CSX-LED SERIES MCPHILBEN MCSLED SERIES			
4⊗△ EX3	COMBINATION EXIT AND EMERGENCY LIGHTING UNIT.	12 1/4" W 4 1/2"x 9"H	CL	LED	5 WATT L.E.D.	120V EB EM MV	Р	EXITRONIX VLED-EL90 OR MATCH EXISTING BUILDING TYPE.			
4	EMERGENCY LIGHTING UNIT.	12 1/4" W 4 1/2"x 9"H	WL	IN	5 WATT MR11	120V EB EM MV	P	MATCH EXISTING BUILDING TYPE. McPHILBEN CF6 SERIES			

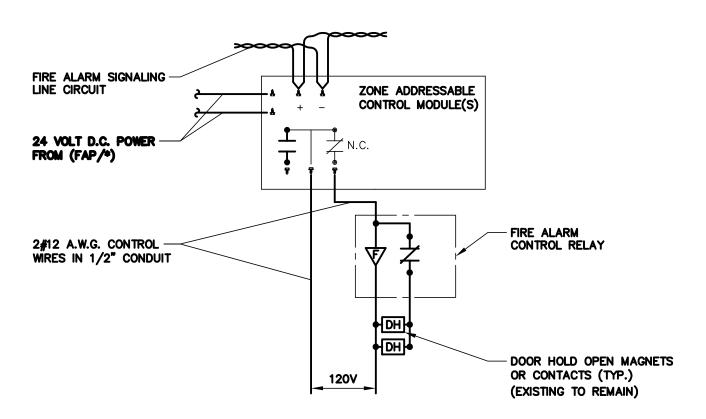

SMOKE DOOR RELEASE DETAIL

NO SCALE
NOTES

1. SEQUENCE OF OPERATION: DOOR HOLD OPENS ARE ENERGIZED THRU CONTROL MODULE UPON ACTIVATION OF ANY SMOKE DETECTOR ON FLOOR, DOORS WILL BE RELEASED. UPON ACTIVATION OF ANY SMOKE DETECTOR ON FLOOR ABOVE OR BELOW, DOORS WILL BE RELEASED.

SYSTEM INPUTS	EQUENCE OF OPERATION	PANEL/ANNUNCIATOR ALARM INDICATION	PANEL/ANNUNCIATOR SUPERVISORY INDICATION	PANEL/ANNUNCIATOR TROUBLE INDICATION	AUDIBLE ALARMS SEQUENCE	VISUAL ALARMS SEQUENCE	ELECTRIC SPRINKLER AUDIO/VISUAL SEQUENCE	SPRINKLER PREACTION ACTIVATION SEQUENCE	AHU SHUTDOWN SEQUENCE	ELEVATOR RECALL SEQUENCE	ELEVATOR SHUTDOWN SEQUENCE	DOOR HOLDER SEQUENCE	RELEASE AGENT DISCHARGE SEQUENCE
FIRE ALARM PANEL, TRANSPONDER, LOW BATTERY	NAC PANEL		X										
FIRE ALARM PANEL, TRANSPONDER, BATTERY OR CHARGER FAILURE	NAC PANEL			X									
FIRE ALARM PANEL, TRANSPONDER, ABNORMAL SWITCH OR CONTROL PO	NAC PANEL SITION.		X										
FIRE ALARM PANEL, TRANSPONDER, GROUND FAULT, OPEN CIRCUIT, SHO	NAC PANEL RT CIRCUIT			X									
FIRE ALARM PANEL, TRANSPONDER, AC POWER LOSS OR IRREGULARITY	NAC PANEL			X									
NOTIFICATION APPLIANCE CIRCUIT OR SLC LOOP GROUND FAULT, OPEN CIRCUIT, SHORT CIRCUIT				X									
INITIATING DEVICE FAILURE OR COMMUNICATION ERROR				X									
FIRE ALARM PANEL MANUAL FIRE DRILL			X		X	X							
MANUAL PULL STATION	F	X			X	X							
SMOKE DETECTOR	SD	X			X	X							
HEAT DETECTOR	H	X			X	X							
SPRINKLER SYSTEM FS	MM	X			X	X	X	X					
SPRINKLER SYSTEM MONITOR SWITCH	MM		X										
SPRINKLER SYSTEM CABINET MONITOR (UPS ROOM)	MM		X										
SMOKE DETECTOR FOR HVAC CONTROL			X						X				
SMOKE DETECTORS IN ELEVATOR LOBBIES	(SD) _E	X			X	X				X	X		
SMOKE DETECTORS IN ELEVATOR MACHINE ROOM & HOISTWAY	SD _E	X			X	X				X	X		
HEAT DETECTOR NEAR ELEVATOR SPRINKLERS	Θ_{E}	X			X	X					X		
ELEVATOR SHUNT TRIP CIRCUIT POWER FAILURE	MM E1		X										
SMOKE DETECTOR AT DOOR HOLD	SD _{DH}	E2			X	X						X	
SMOKE DETECTOR IN COMPUTER ROOM	(SD) _{PR}	X			X	X			E 2				
RELEASE AGENT SYSTEM PANEL ALARM	MM	X			<u>X</u>	<u>X</u>			E2				<u> X</u>
RELEASE AGENT SYSTEM PANEL TROUBLE	MM			X									
INFRARED BEAM SMOKE DETECTOR	SD _{BT} MM	X			X	Χ							


FIRE ALARM OPERATION MATRIX

E2 UPON DETECTION BY (2) TWO SMOKE DEVICES.


ALL SYSTEM EVENTS SHALL BE LOGGED, PRINTED, AND DISPLAYED ON THE FACP DISPLAY. SEE SPECIFICATIONS FOR MORE INFORMATION AND DESCRIPTIONS OF SEQUENCES OF OPERATION.

KEYNOTES:

E1 UTILIZE A GENERAL PURPOSE RELAY TO MONITOR POWER LOSS. CONNECT THE CONTACTS OF THE RELAY TO A FIRE ALARM MONITOR MODULE.

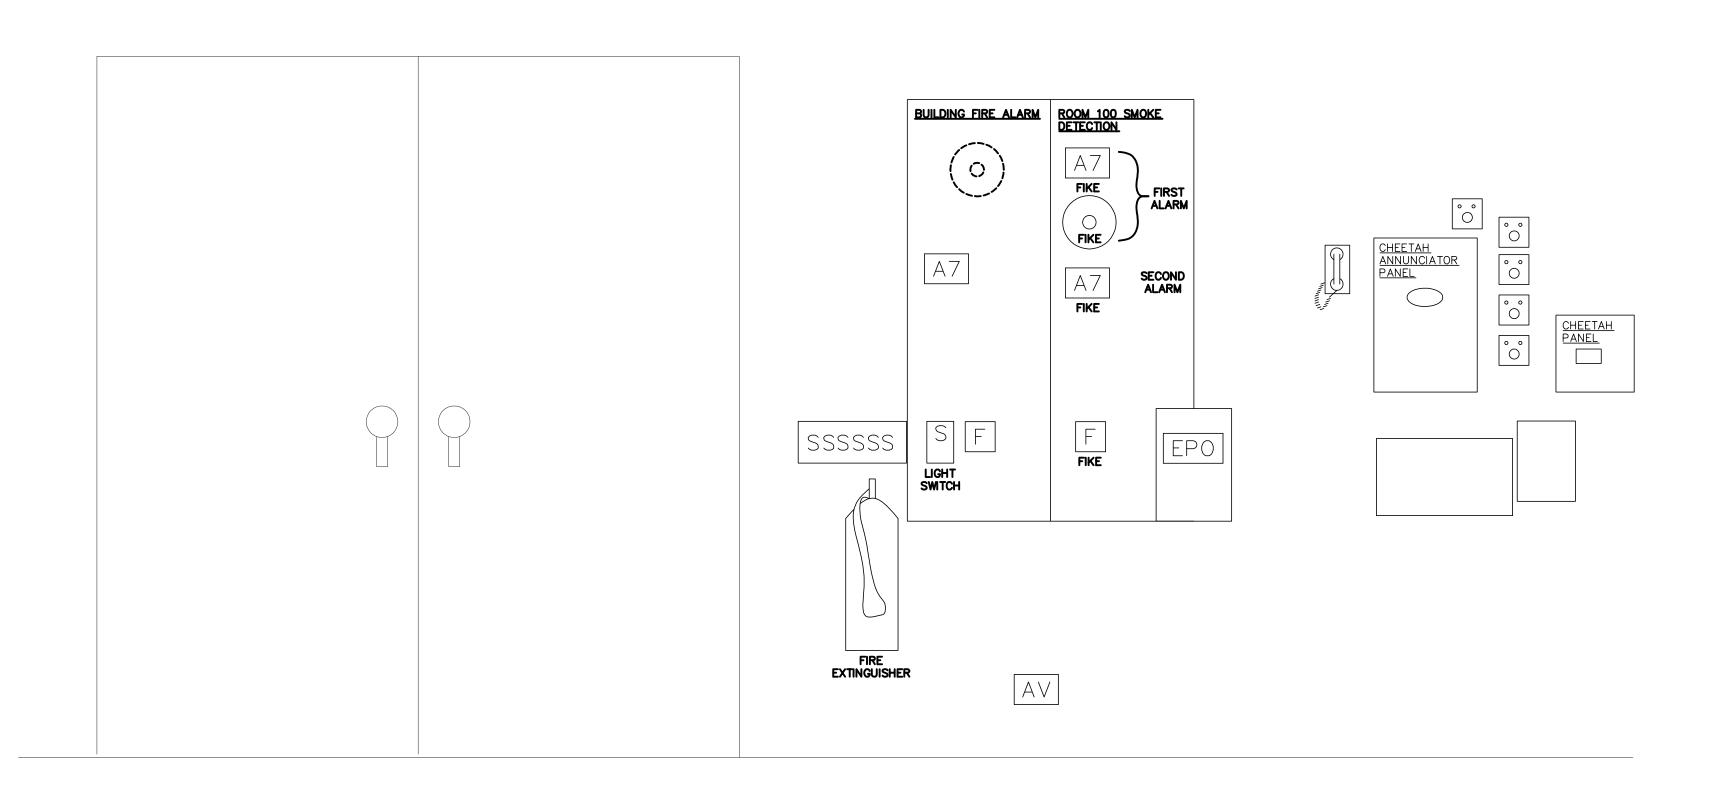

PREACTION SUPPRESSION SYSTEM WALL DETAIL ROOM 100
NO SCALE

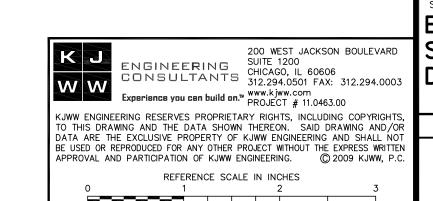




. 2 69

04.06.12 ISSUED FOR FINAL REVIEW DATE REVISION DESCRIPTION KJWW ENGINEERING RESERVES PROPRIETARY RIGHTS. INCLUDING COPYRIGHTS, TO THIS DRAWING AND THE DATA SHOWN THEREON. SAID DRAWING AND/OR DATA ARE THE EXCLUSIVE PROPERTY OF KJWW ENGINEERING AND SHALL NOT BE USED OR REPRODUCED FOR ANY OTHER PROJECT WITHOUT THE EXPRESS WRITTEN APPROVAL AND PARTICIPATION OF KJWW ENGINEERING. REFERENCE SCALE IN INCHES ESIGNED BY DRAWN BY CHECKED BY EV BJL SRH

03.30.2012 11.0463.00 SHEET DESCRIPTION ELECTRICAL SCHEDULES AND

> SHEET NUMBER E400

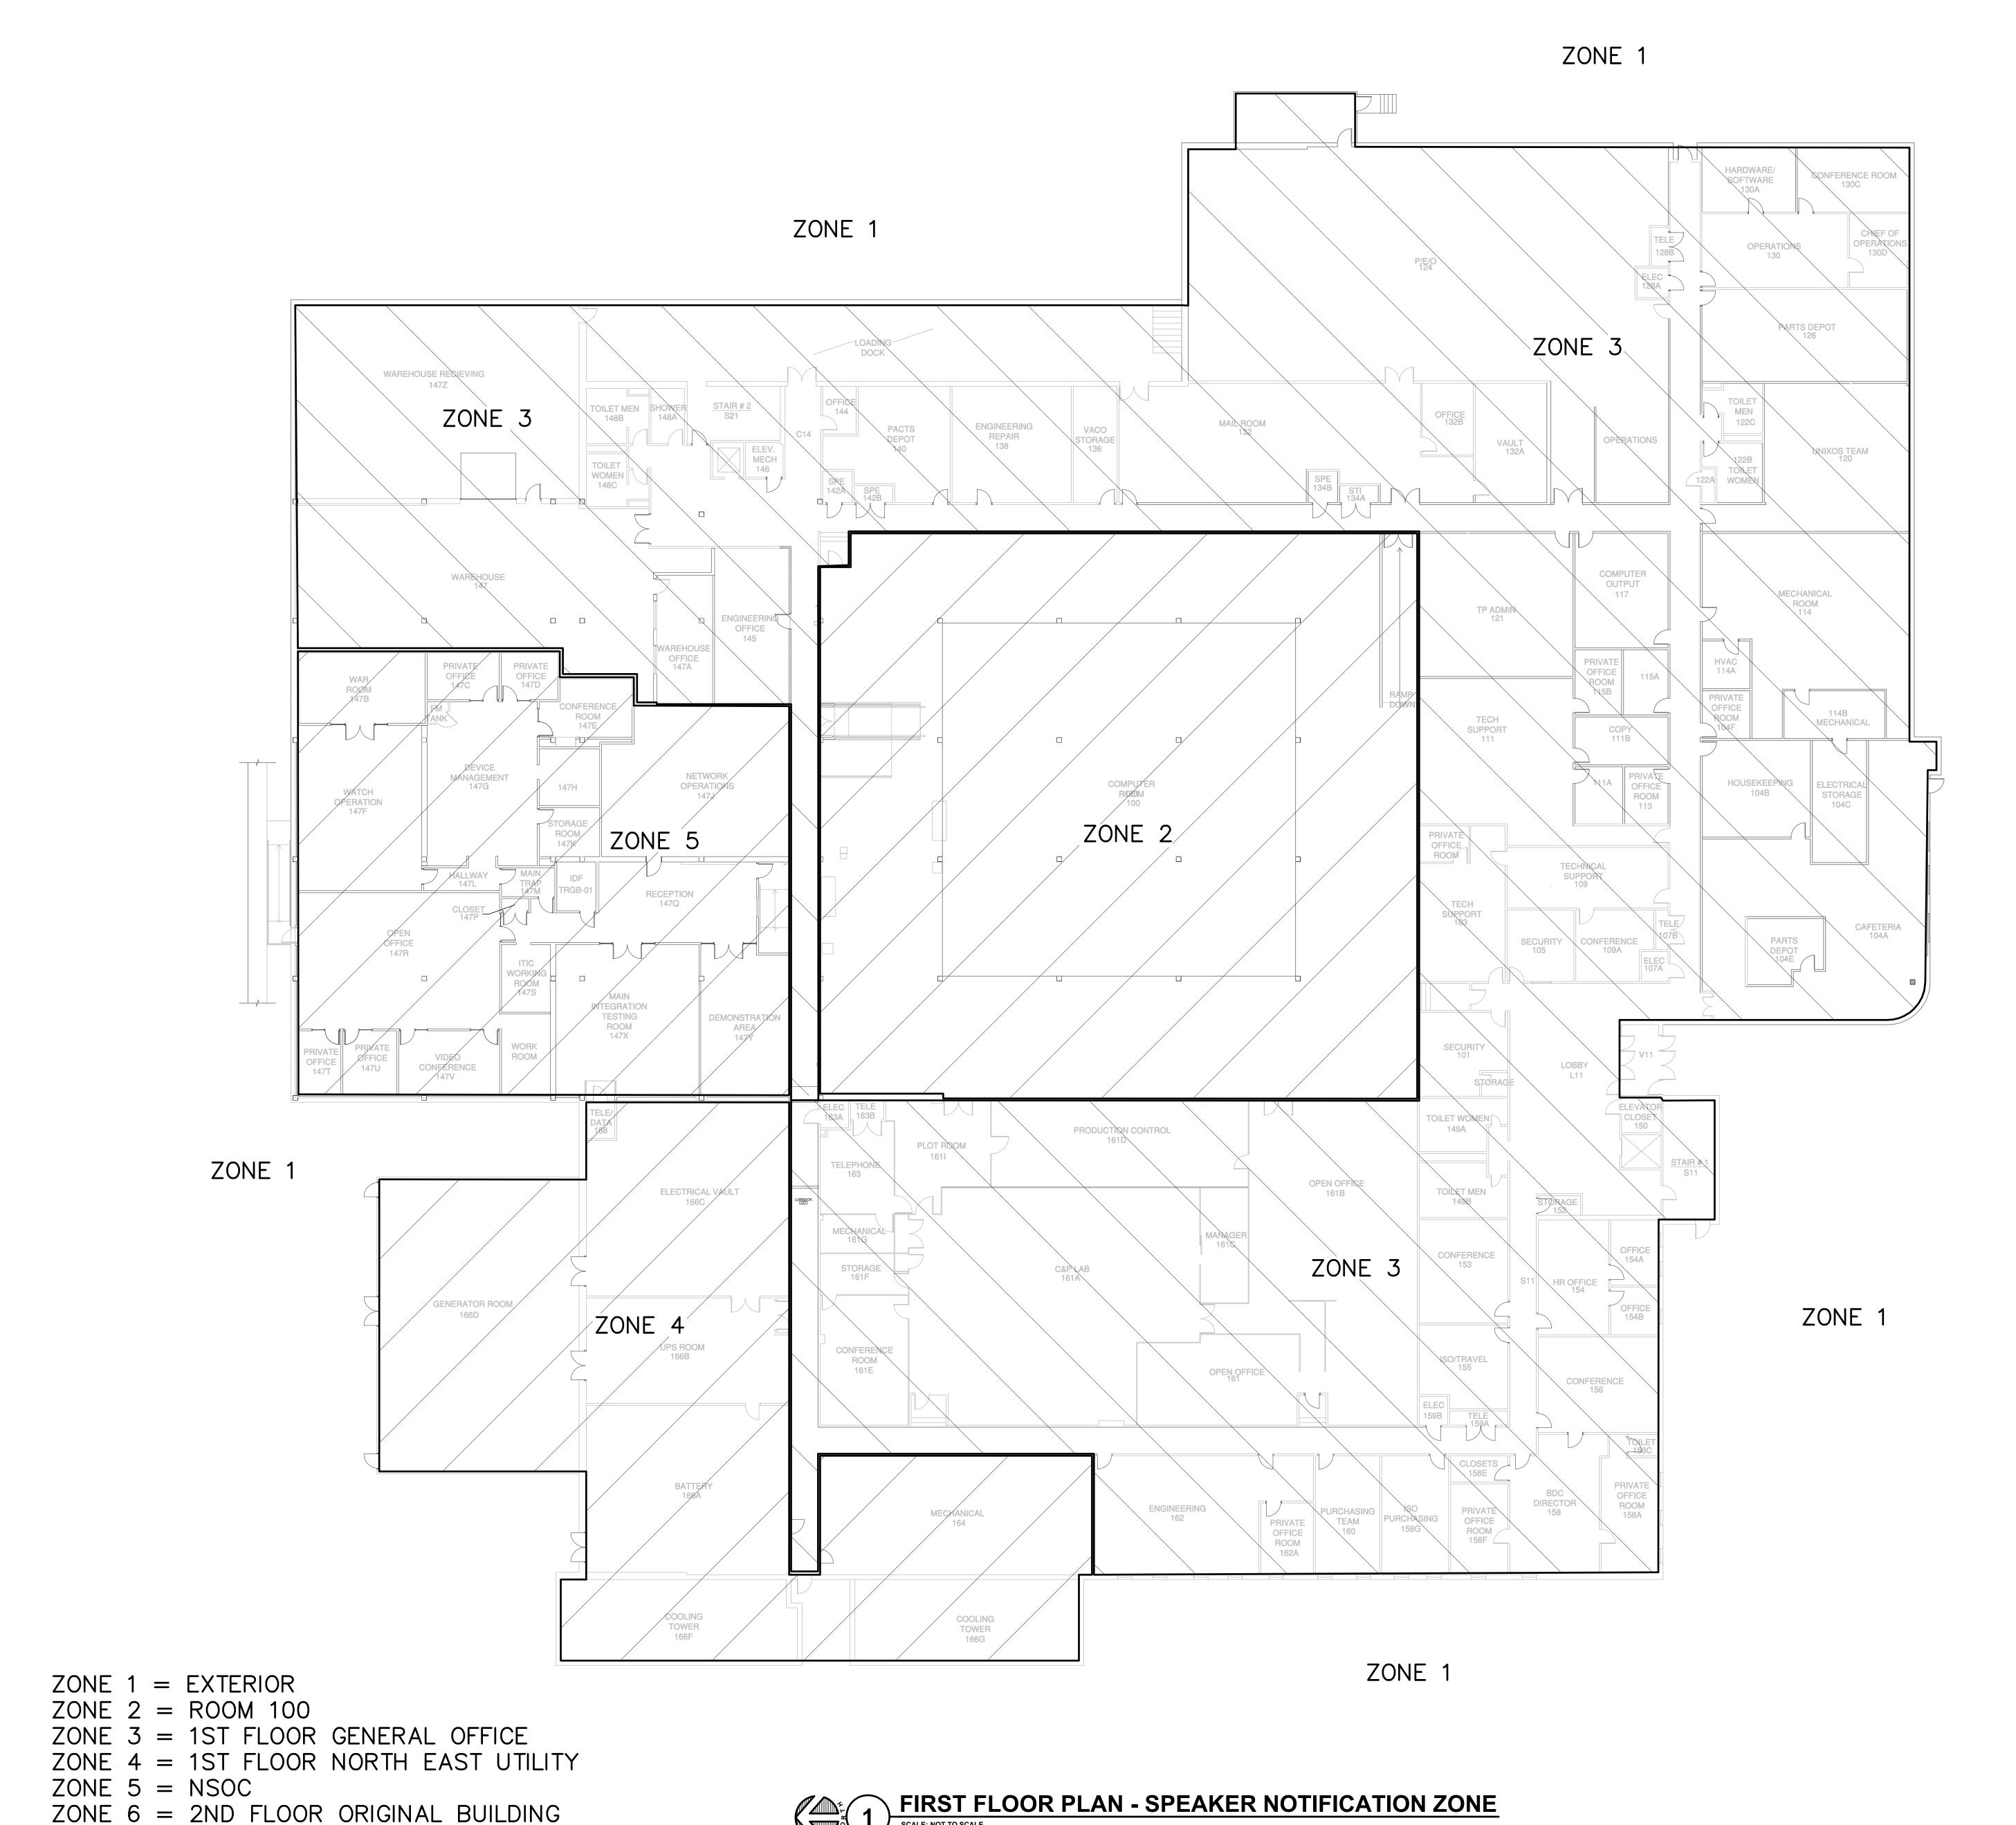

69DP-HINES

ENGINEERING CONSULTANTS

STRUCTURAL | MECHANICAL | ELECTRICAL TECHNOLOGY | MEDICAL EQUIPMENT SOLUTIONS

231 SOUTH LASALLE SUITE 600 CHICAGO, IL 60606 312.294.0501 FAX: 312.294.0003 www.kjww.com

KJWW ENGINEERING RESERVES PROPRIETARY RIGHTS. INCLUDING COPYRIGHTS, TO THIS DRAWING AND THE DATA SHOWN THEREON. SAID

DRAWING AND/OR DATA ARE THE EXCLUSIVE PROPERTY OF KJWW
ENGINEERING AND SHALL NOT BE USED OR REPRODUCED FOR ANY OTHER
PROJECT WITHOUT THE EXPRESS WRITTEN APPROVAL AND PARTICIPATION
OF KJWW ENGINEERING.

© 2009 KJWW, P.C. REFERENCE SCALE IN INCHES

ESIGNED BY DRAWN BY CHECKED BY ΕV 03.30.2012 11.0463.00

SHEET DESCRIPTION
FIRST FLOOR PLAN -SPEAKER NOTIFICATION

ENGINEERING
CONSULTANTS

200 WEST JACKSON BOULEVARD
SUITE 1200
CHICAGO, IL 60606
312.294.0501 FAX: 312.294.0003

Experience you can build on. PROJECT # 11.0463.00

KJWW ENGINEERING RESERVES PROPRIETARY RIGHTS, INCLUDING COPYRIGHTS, TO THIS DRAWING AND THE DATA SHOWN THEREON. SAID DRAWING AND /OR DATA ARE THE EXCLUSIVE PROPERTY OF KJWW ENGINEERING AND SHALL NOT BE USED OR REPRODUCED FOR ANY OTHER PROJECT WITHOUT THE EXPRESS WRITTEN APPROVAL AND PARTICIPATION OF KJWW ENGINEERING.

© 2009 KJWW, P.C.


REFERENCE SCALE IN INCHES

SHEET NUMBER

FIRST FLOOR PLAN - SPEAKER NOTIFICATION ZONE

SCALE: NOT TO SCALE

ZONE 7 = 2ND FLOOR SOUTH ADDITION

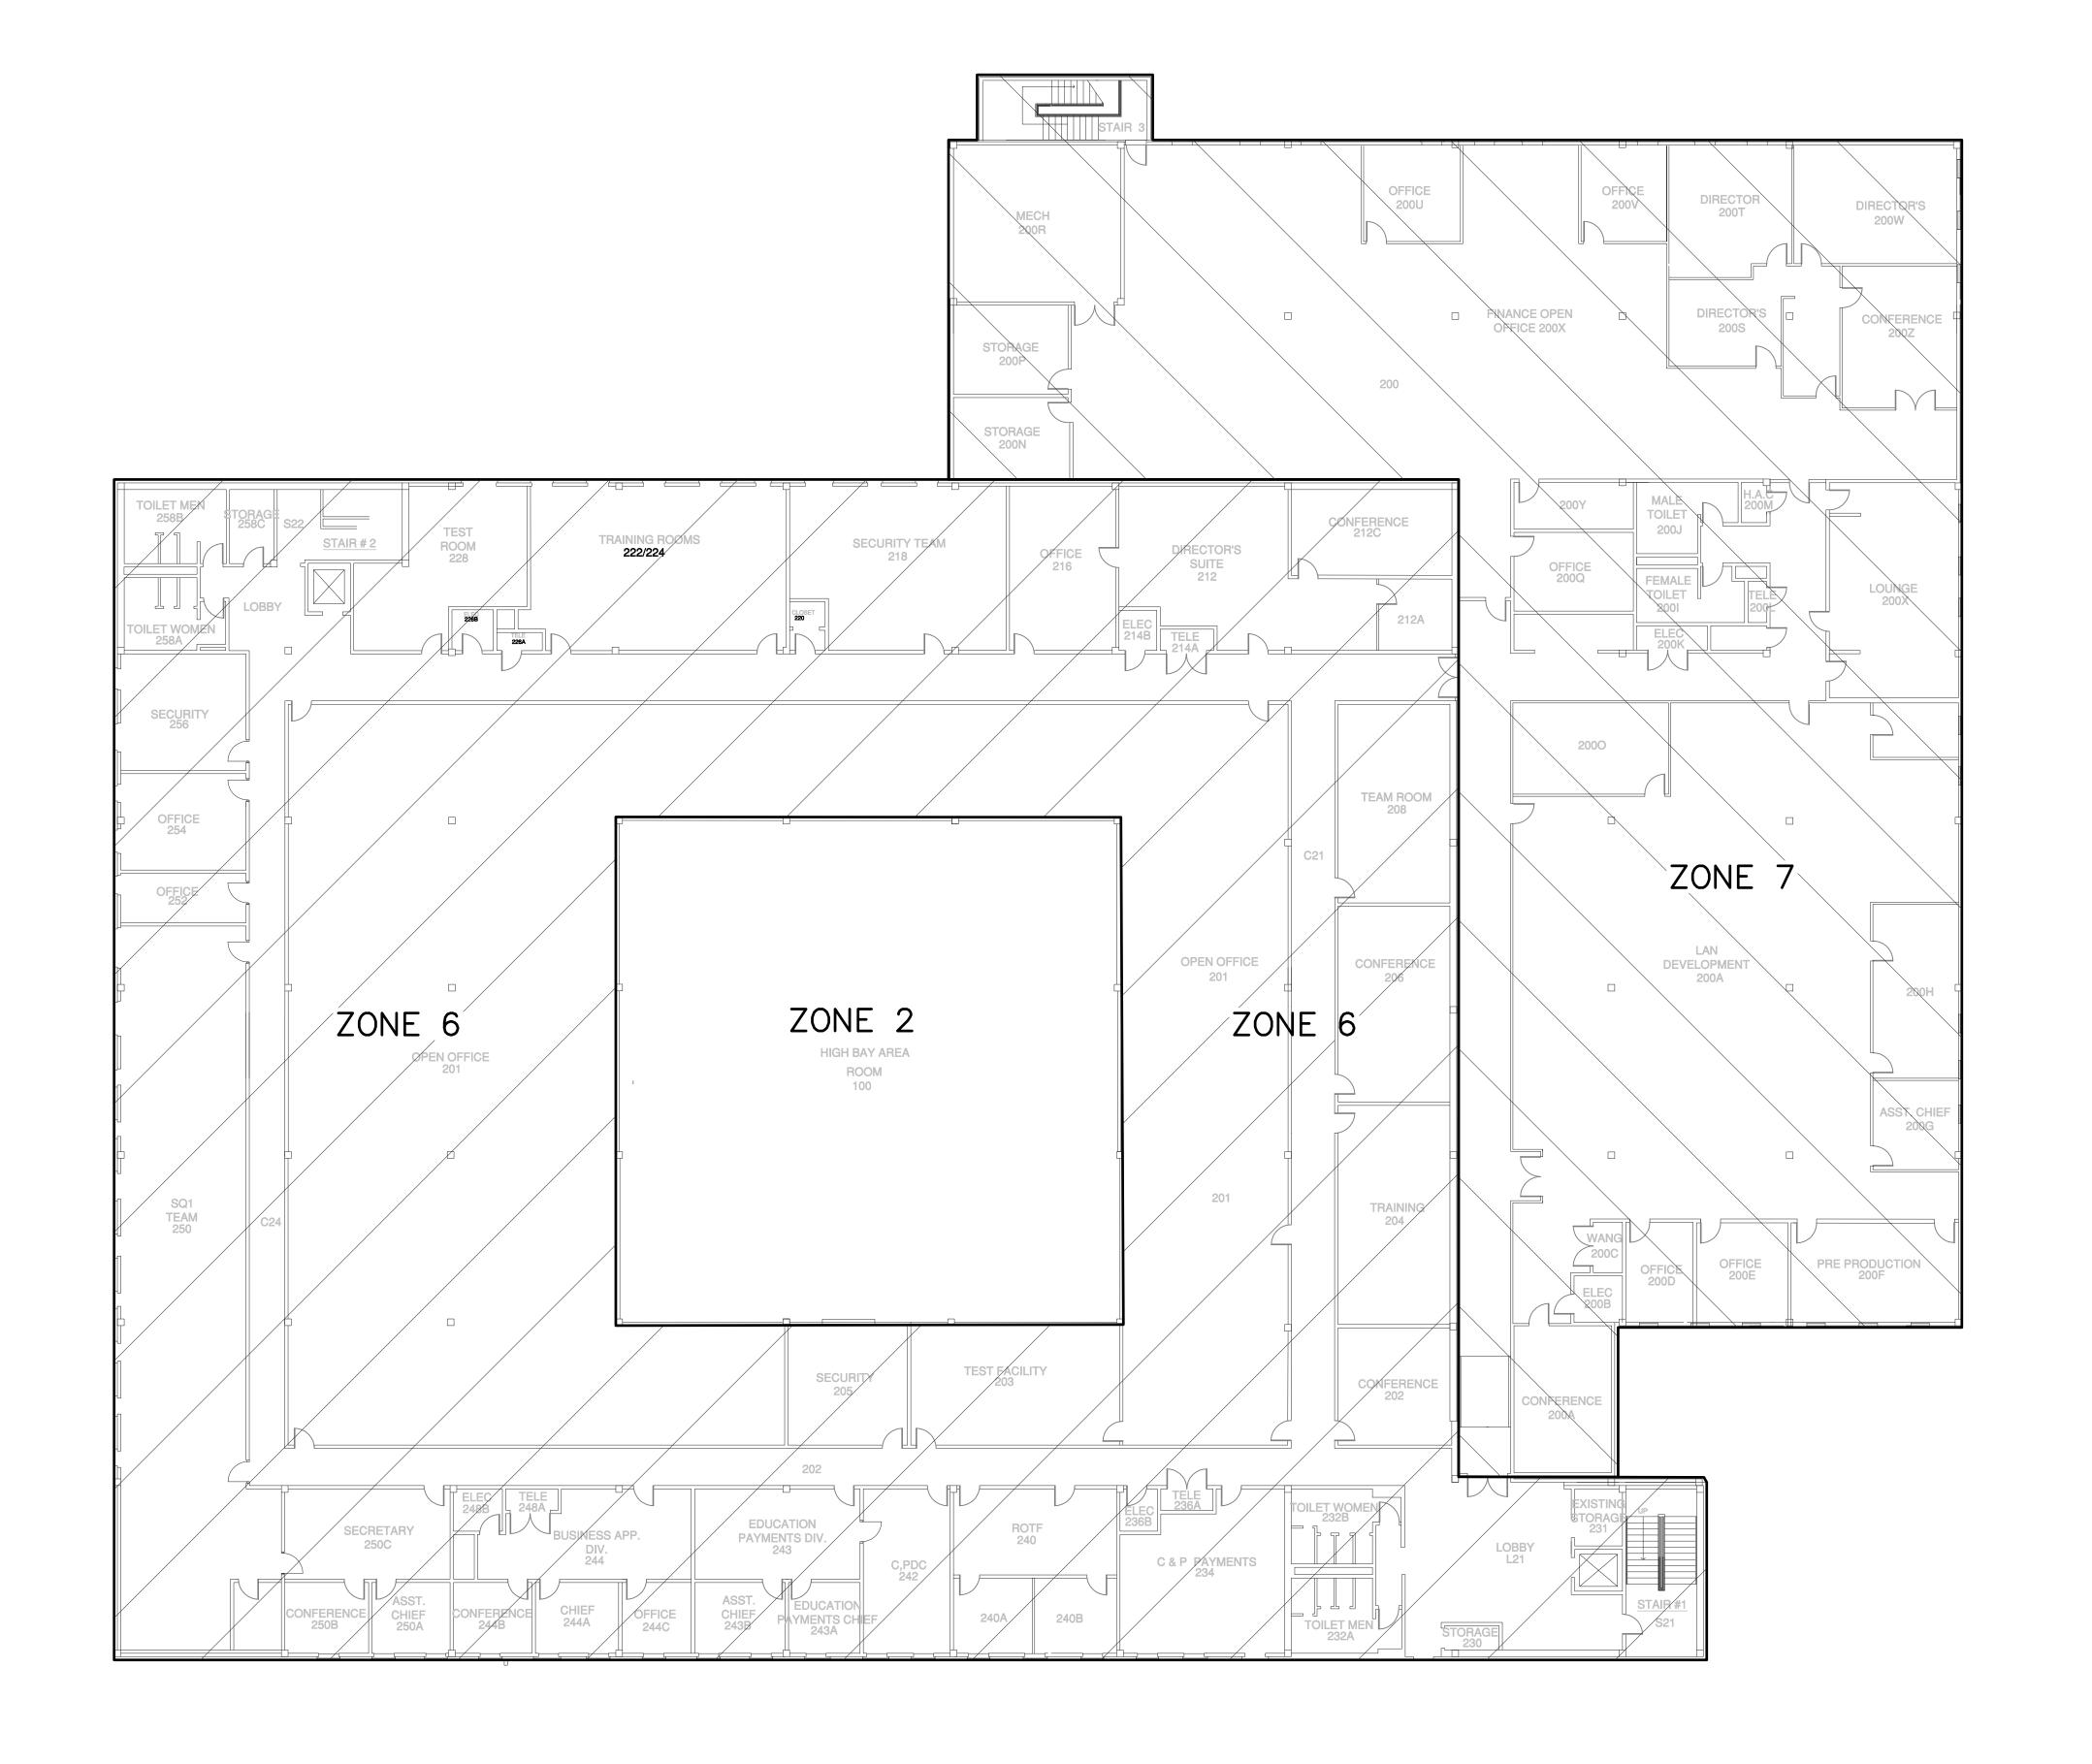

ZONE 1 = EXTERIOR

ZONE 2 = ROOM 100


ZONE 3 = 1ST FLOOR GENERAL OFFICE

ZONE 4 = 1ST FLOOR NORTH EAST UTILITY

ZONE 5 = NSOC

ZONE 6 = 2ND FLOOR ORIGINAL BUILDING ZONE 7 = 2ND FLOOR SOUTH ADDITION SECOND FLOOR PLAN - SPEAKER NOTIFICATION ZONE

SCALE: NOT TO SCALE

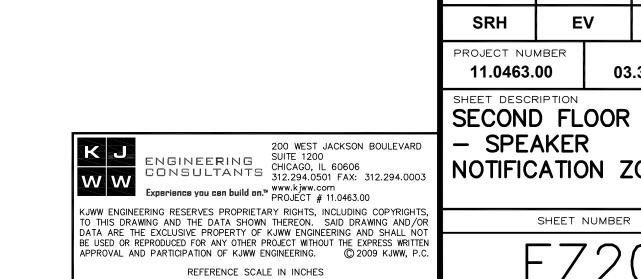

O4.06.12 ISSUED FOR FINAL REVIEW

NO. DATE REVISION DESCRIPTION

KJWW ENGINEERING RESERVES PROPRIETARY RIGHTS, INCLUDING COPYRIGHTS, TO THIS DRAWING AND THE DATA SHOWN THEREON. SAID DRAWING AND/OR DATA ARE THE EXCLUSIVE PROPERTY OF KJWW ENGINEERING AND SHALL NOT BE USED OR REPRODUCED FOR ANY OTHER PROJECT WITHOUT THE EXPRESS WRITTEN APPROVAL AND PARTICIPATION OF KJWW ENGINEERING.

REFERENCE SCALE IN INCHES

O

1

2

DESIGNED BY

DRAWN BY

CHECKED BY

SRH

EV

BJL

PROJECT NUMBER

11.0463.00

DATE

03.30.2012

SHEET DESCRIPTION

SECOND FLOOR PLAN

- SPEAKER

NOTIFICATION ZONE

69DP-HINES